


CANTERBURY BANKSTOWN CITY COUNCIL MR508 HENRY LAWSON DRIVE

UPGRADE BETWEEN TOWER ROAD AND AULD AVENUE BRIDGE MILPERRA - STAGE 1A

ROAD DESIGN

80% CONCEPT - REFERENCE DESIGN

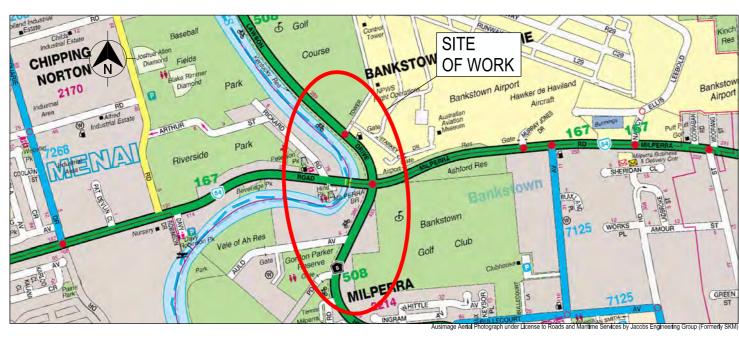


PART INDEX

PART NUMBER	CODE	NAME
PART 1	CO	COVER SHEET
	LG	LEGENDS
	TY	TYPICAL CROSS SECTIONS
	RD	PLAN AND LONG SECTION
	UT	UTILITIES AND STORMWATER MANAGEMENT
	PV	PAVEMENT (PROVIDE SEPARATELY)
PART 2	RC	ROAD CROSS SECTIONS
PART 3	PW	PROPERTY WORKS

LOCALITY PLAN

8															
30															
	DRAWING FILE LOCATION / NAME						PLOT DATE / TIME	PLOT BY	CLIENT		CANTERBURY - BANKSTOWN CITY COUNCIL				A3
K:\CADD\Design\pds14\Henry Lawson Drive and Milpera Road\Drawings\CAD\Sheets\\80% DS2019-001427-CO.dgn			۶ ا				4/09/2020 3:16:44 PM ngukinh				MR508 HENRY LAWSON DRIVE				
50	PREPARED BY	DESIGNED	REVIEWED		VERIFIED	RECOMMENDED	TFNSW PROJECT MANAGER				UPGRADE E	BETWEEN TOW	ER ROAD AND	AULD AVEN	1UE
		1					NAME S.ABID		NSW GOVERNMENT	Transport	BRIDGE - M	ILPERRA			
-	INFRASTRUCTURE AND PLACE	SIGNED	SIGNED		SIGNED	SIGNED	TITLE PROJECT MANAGER		GOVERNMENT	for NSW	RMS PROJECT No.		DESIGN PROJECT No.		
110	TECHNICAL SERVICES	NAME V.NGUYEN	NAME B.CARTWRIG	GHT	NAME T.HUFTON	NAME J.HOGAN	VALIDATION AND ACCEPTANG	CE OF THESE	PREPARED FOR		P.0036089 RMS REGISTRATION N		SF2019/233157		PART
5	ENGINEERING SERVICES	TITLE ROAD DESIGNER	TITLE LEAD ROAD [DESIGNER	TITLE ROAD DESIGN MANAGER	MANAGER ROAD DESIGN	DRAWINGS AND THE DESIGN		SYDNEY PROJECT	Γ DELIVERY	TUNGTEGICITION	<u> </u>	01427		1
	WESTERN SYDNEY ROAD DESIGN				THEE.	nite.	THEREON IS TO BE CARRIED			Y PROJECT OFFICE	ISSUE STATUS	REFERENCE DESIGN	EDMS No.	SHEET No. CO-0001	ISSUE
0	West Entire of British to the Best State of the State of	DAIE	DAIL		DATE	DAIL	SEPARATE PROCESS	I	GREATER SYDNEY	Y PROGRAM	80% CONCEPT -	REFERENCE DESIGN	SF2019/233137	CO-000	1A 1

| 15 | 20 | 25 | 30 | 35 | 40 | 45 | 50mm ON A3 SIZE ORIGINAL

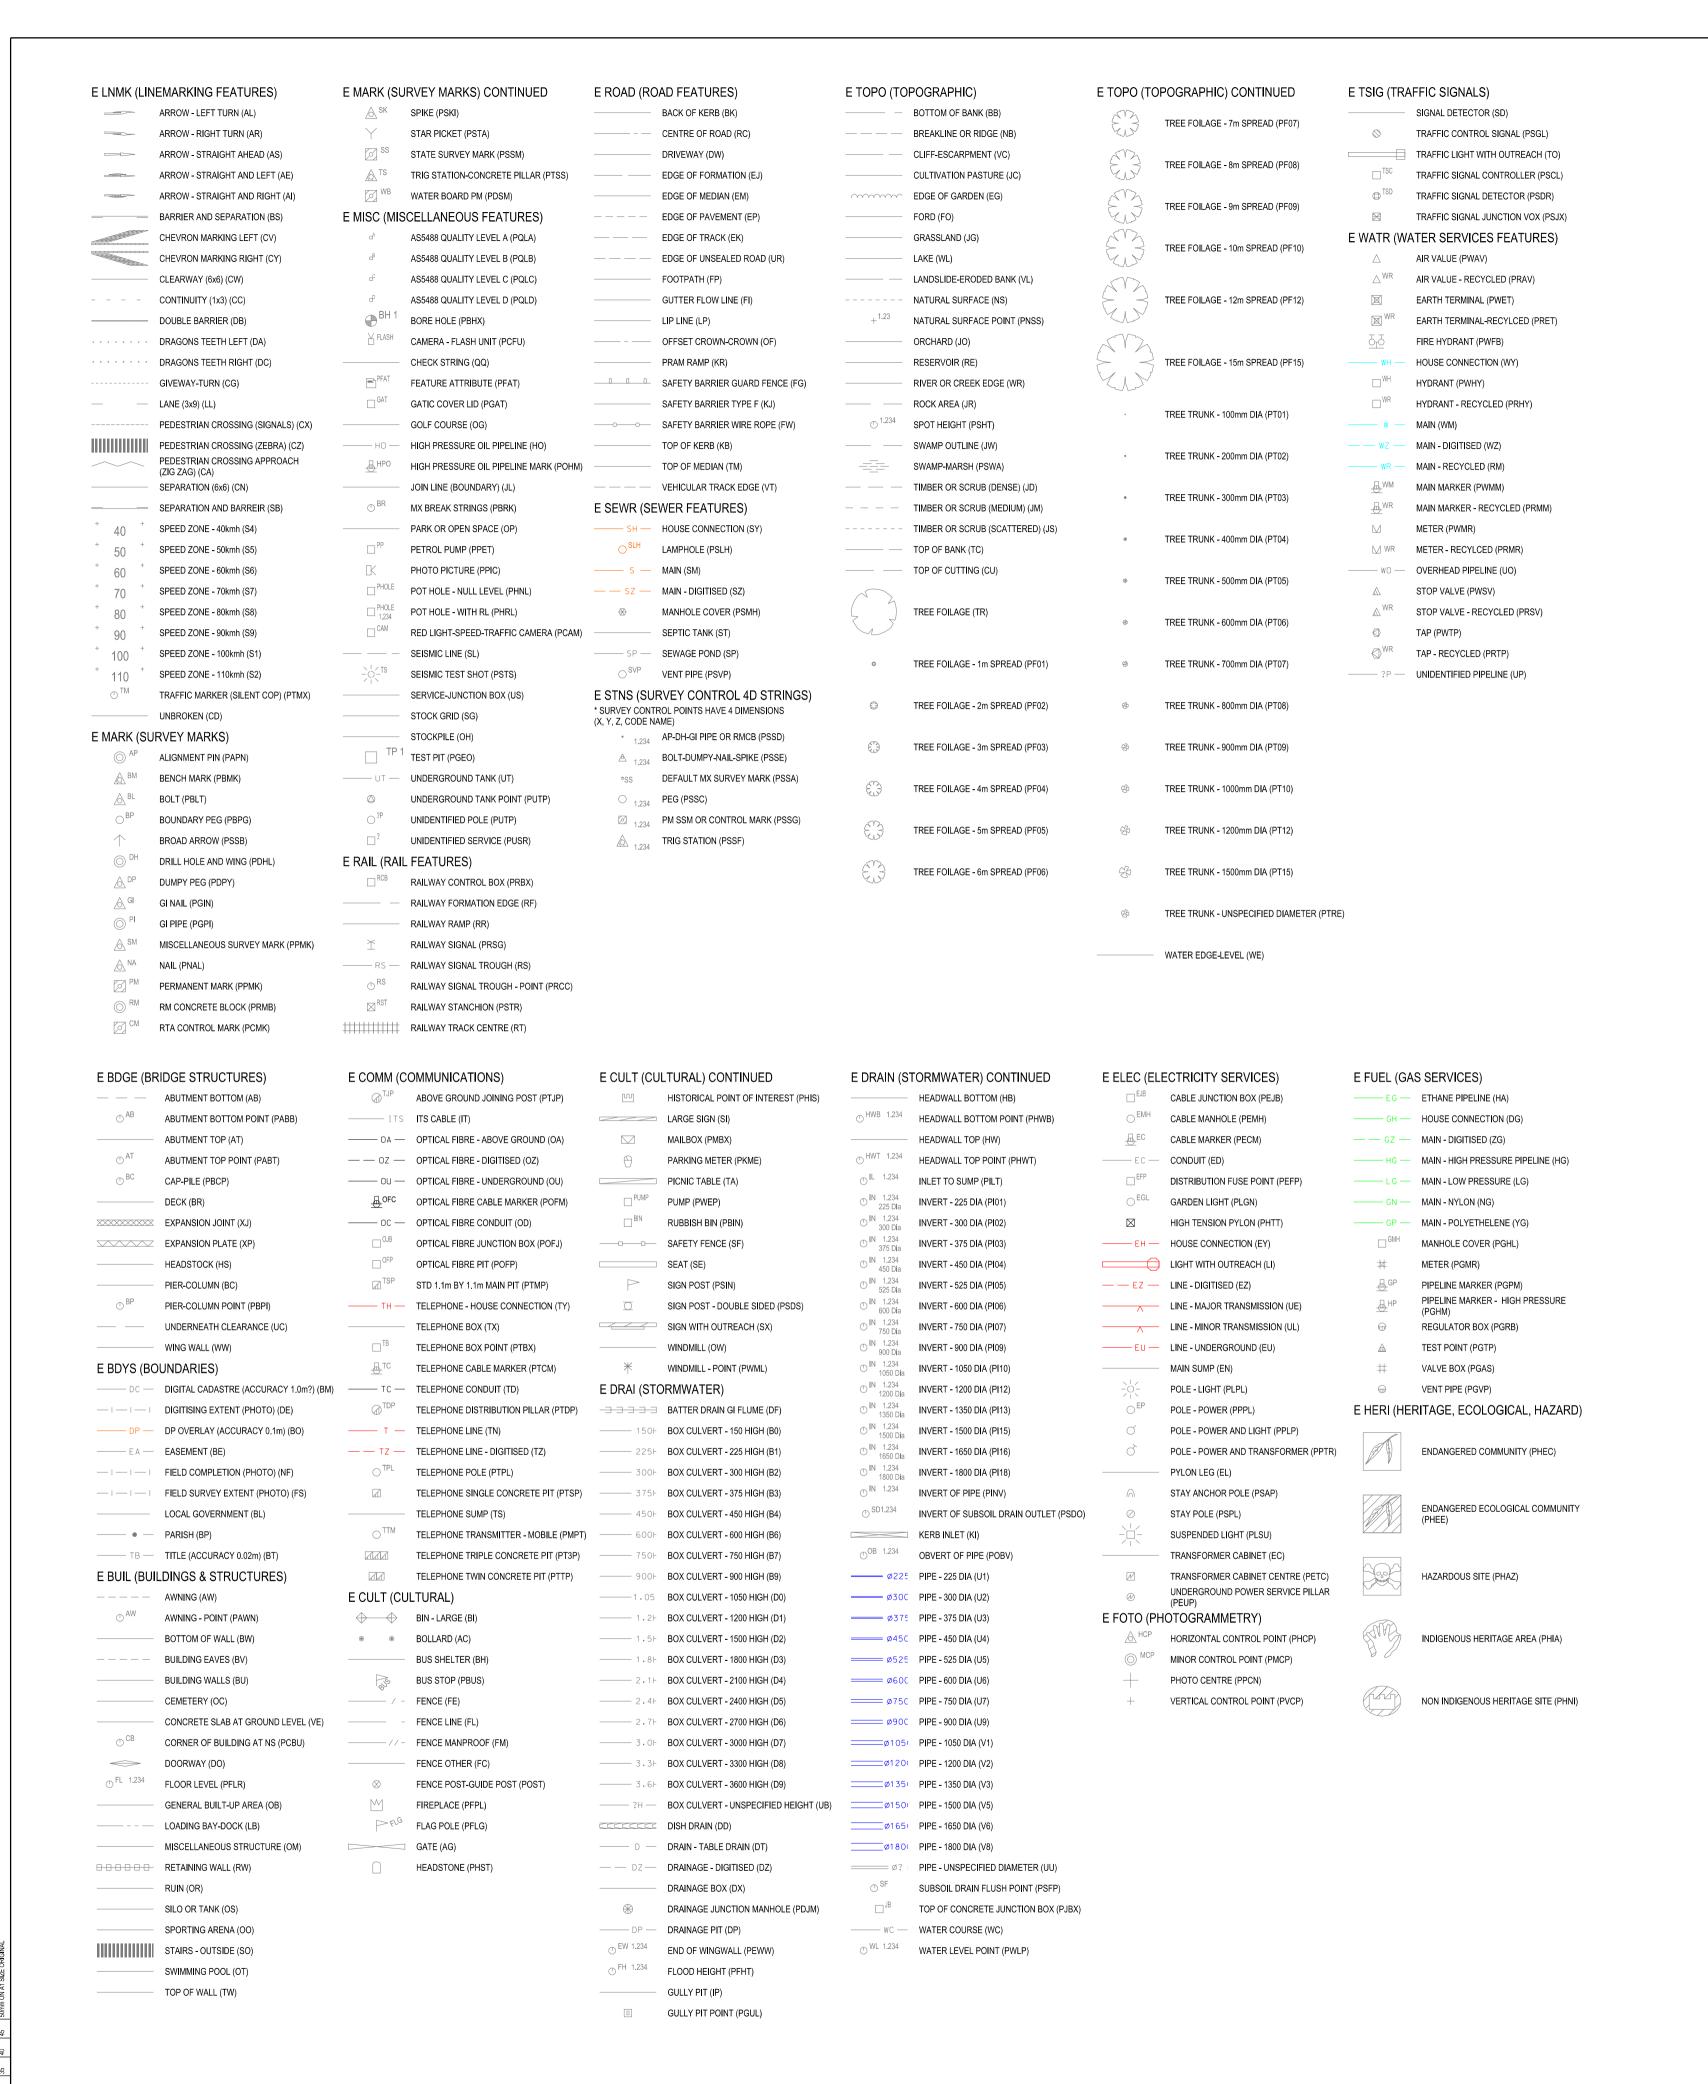

NOTES

GENERAL LEGENDS

CONTROL LINE LABEL

PROPOSED BOUNDARY

SA BARRIER KERB AND GUTTER

SF RAISED MEDIAN/TRAFFIC ISLAND

INSTALL AR3 - EXCLUSIVE TURN ARROW (RIGHT)

INSTALL AR3 EXCLUSIVE TURN ARROW (LEFT)

ROAD FUNITURE, SIGNAGE AND LINEMARKING

L1 LANE LINE

- - - - C1 CONTINUITY LINE

---- PCW CROSSING LINE

REV DATE AMENDMENT / REVISION DESCRIPTIO

04-05-2020 ISSUED FOR 20% DESIGN

02 29-05-2020 ISSUED FOR 50% DESIGN


03 31-08-2020 ISSUED FOR 80% DESIGN


- ALL WORKS SHALL BE CARRIED OUT IN ACCORDANCE WITH THE SPECIFICATIONS FOR THESE WORKS AND/OR WITH CURRENT R.M.S STANDARDS.
- ALL EXISTING SERVICES SHALL BE LOCATED AND CONFIRMED LEVELS PRIOR TO COMMENCING DETAILED DESIGN AND CONSTRUCTION. PROTECT AND MAKE ARRANGEMENTS WITH THE RELEVANT AUTHORITY TO RELOCATE AND/OR ADJUST IF NECESSARY. INFORMATION GIVEN ON THE DRAWINGS IN RESPECT TO SERVICES IS FOR GUIDANCE ONLY AND IS NOT GUARANTEED COMPLETE NOR ACCURATE.
- ALL CHAINAGES AND LEVELS ARE IN METRES. ALL LEVELS ARE A.H.D AND CO-ORDINATES ARE M.G.A. CO-ORDINATES AND LEVELS OBTAINED FROM SURVEY BY RMS.


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DESIGN MNGR TIM HUFTON 29.05.20
PROJECT MNGR SARAH ABID 29.05.20
SYDNEY NORTH CO-ORDINATE SYSTEM HEIGHT DATUM
MGA ZONE 56 (GDA94) AHD




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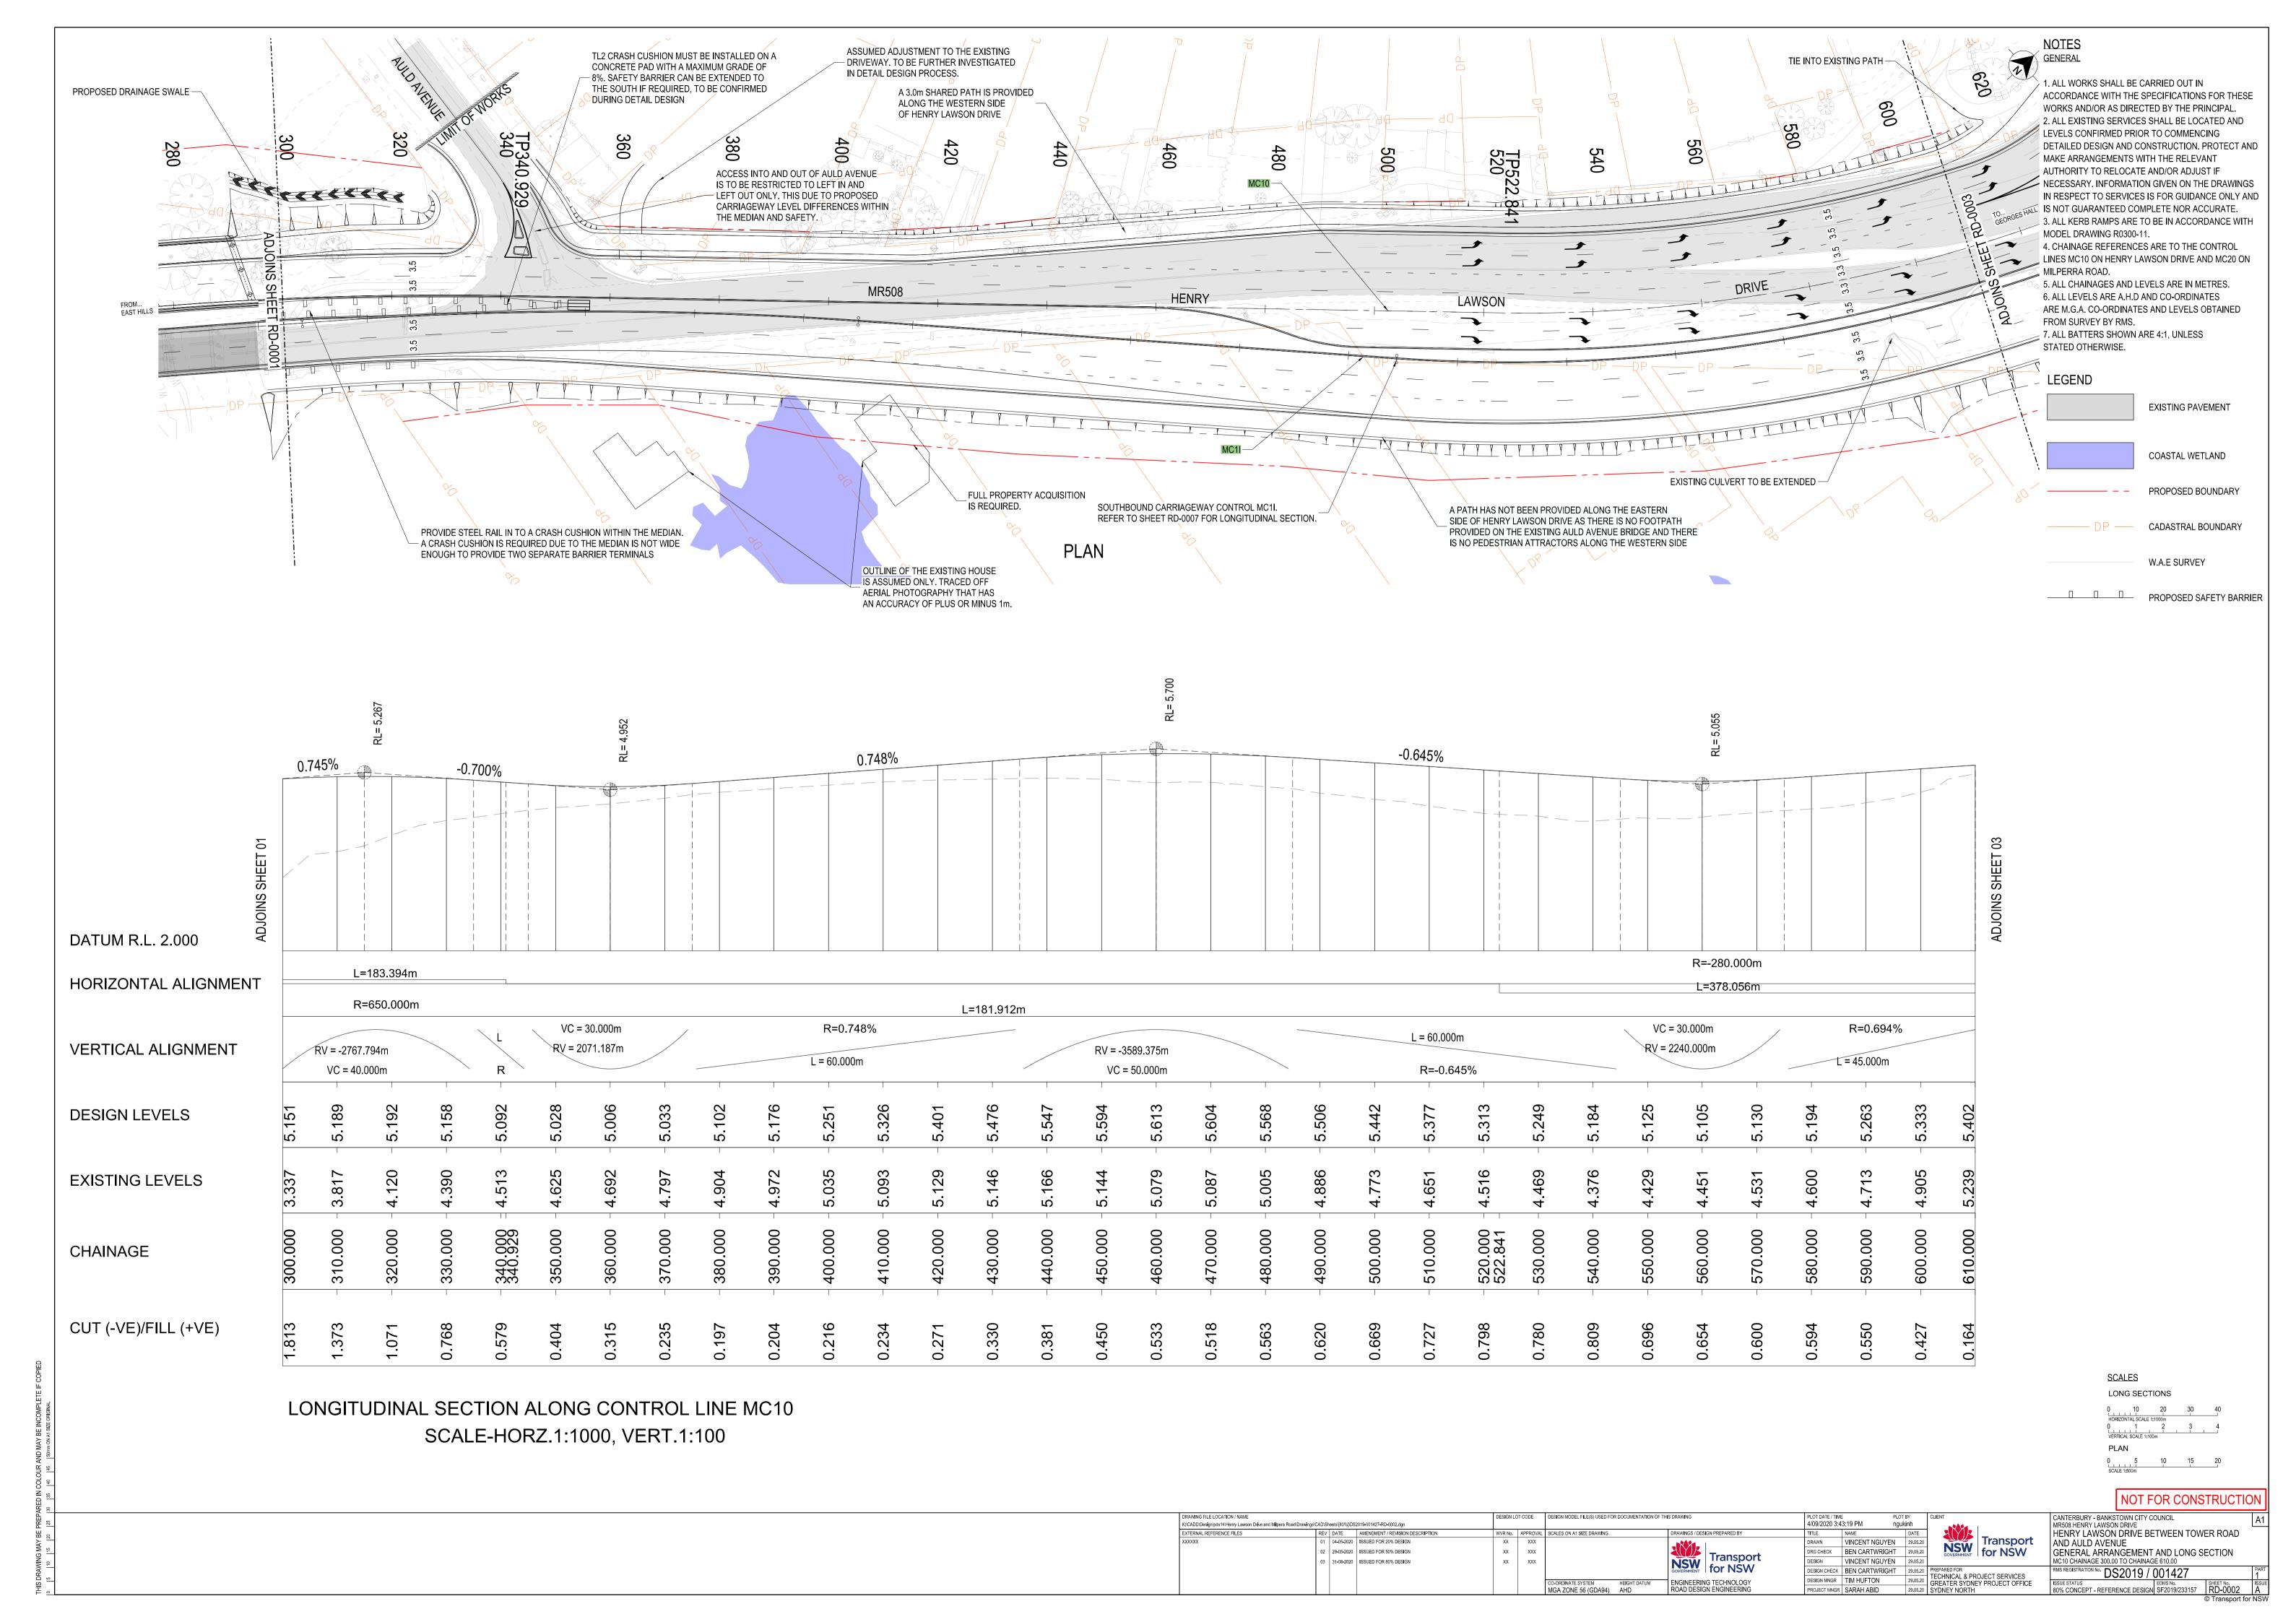


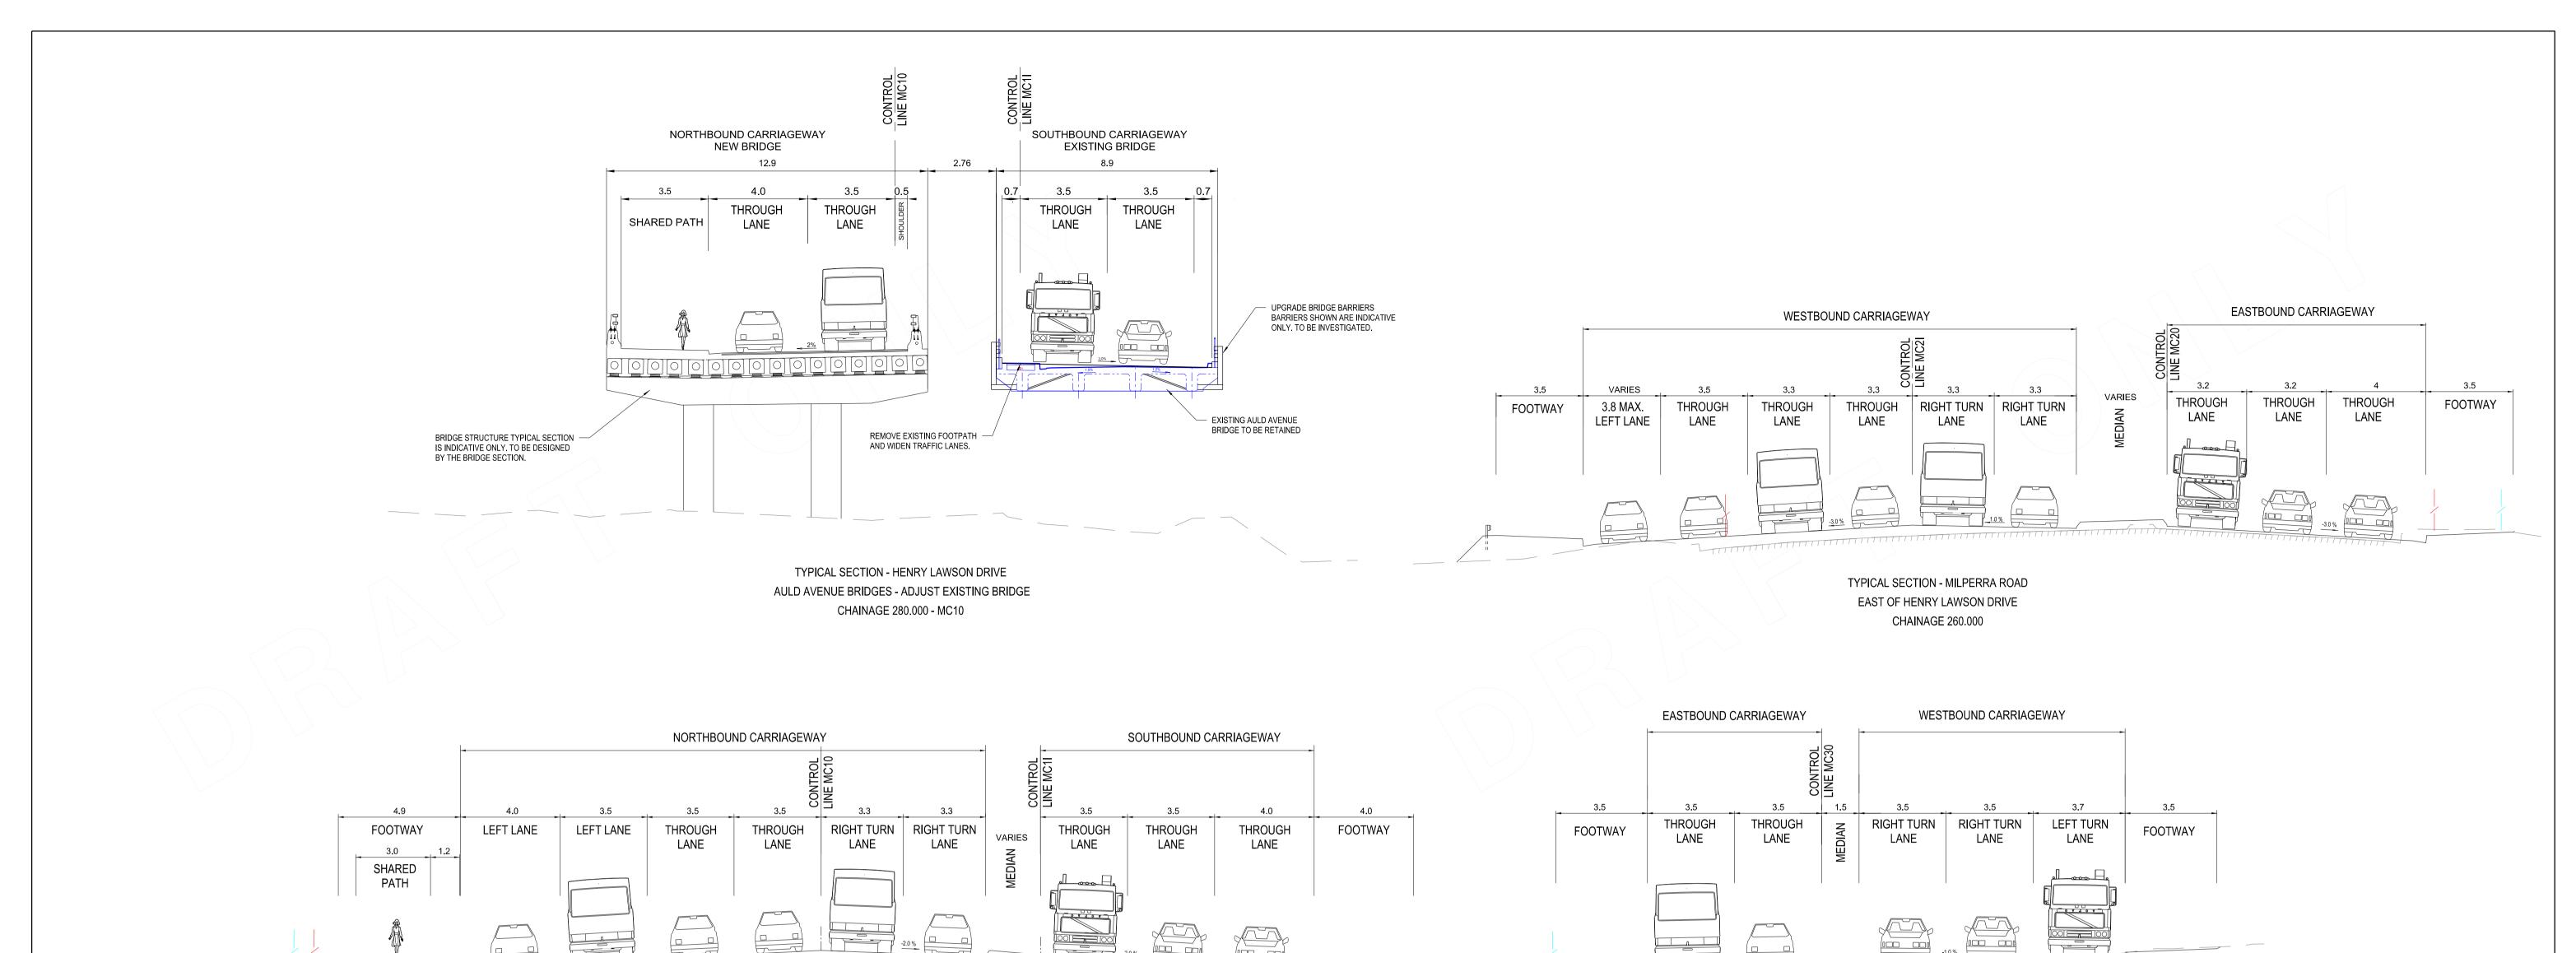
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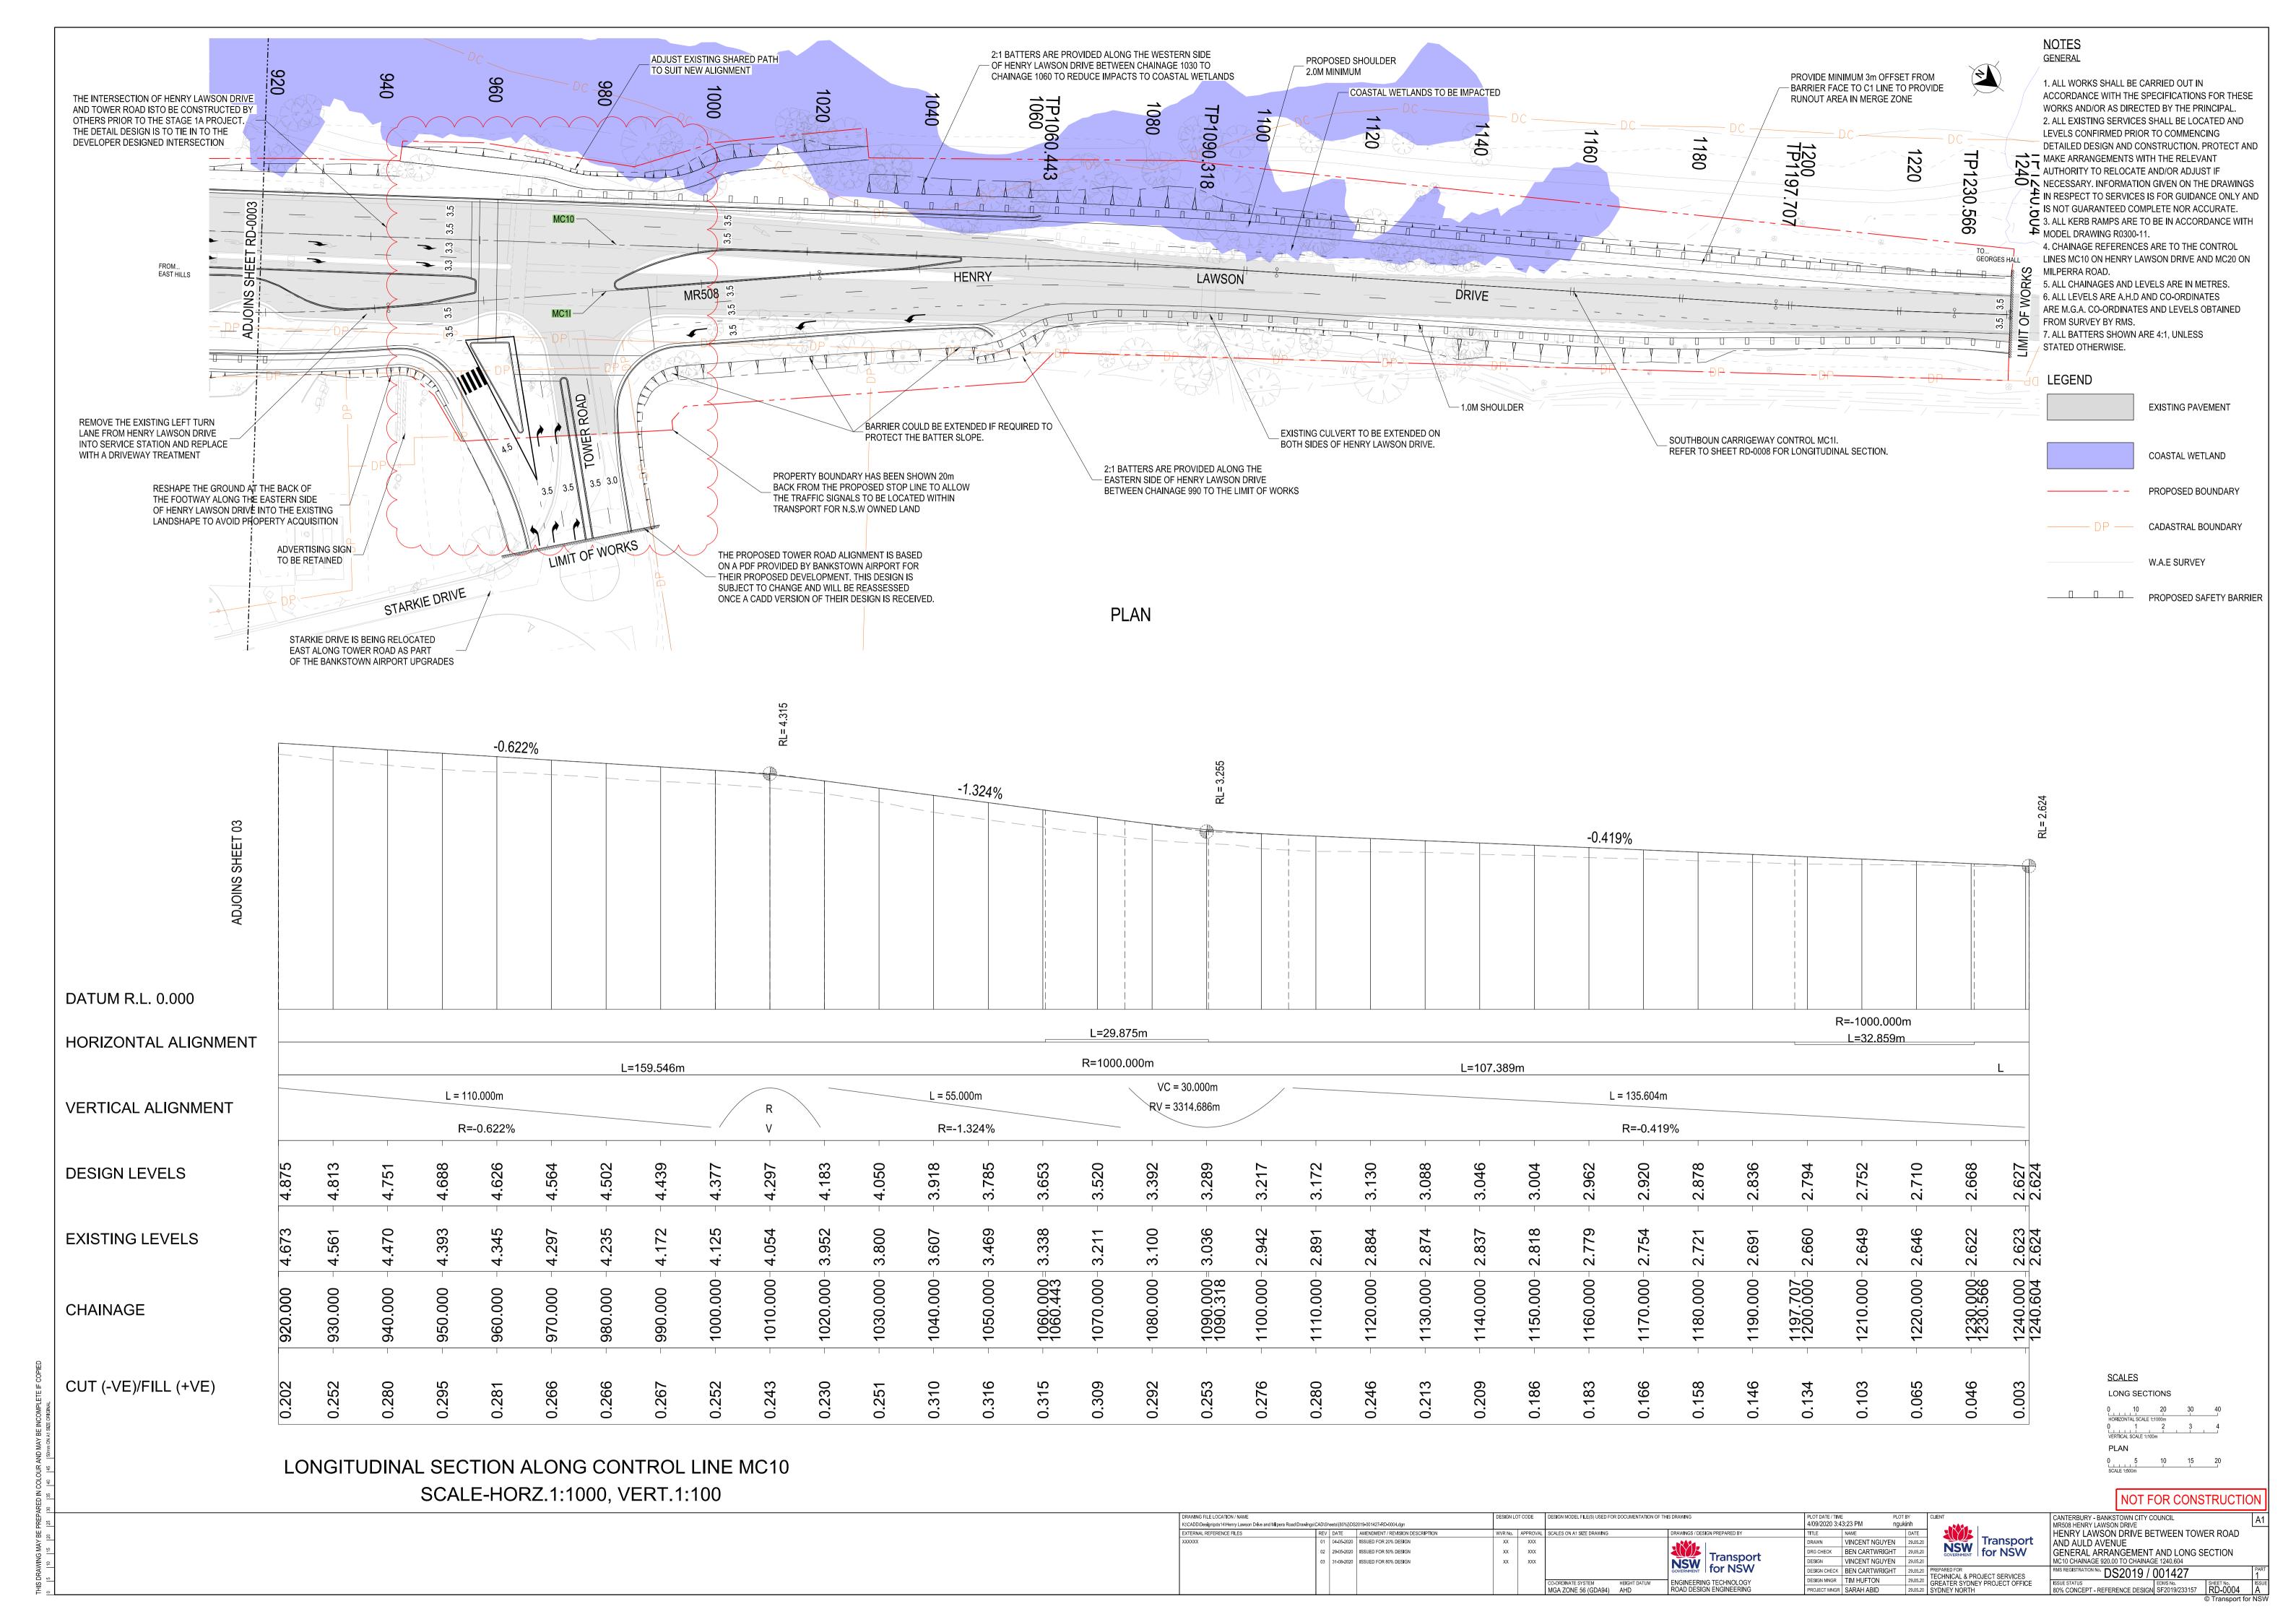


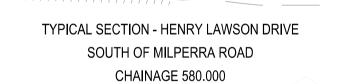
TYPICAL SECTION - HENRY LAWSON DRIVE NORTH OF MILPERRA ROAD CHAINAGE 760.000

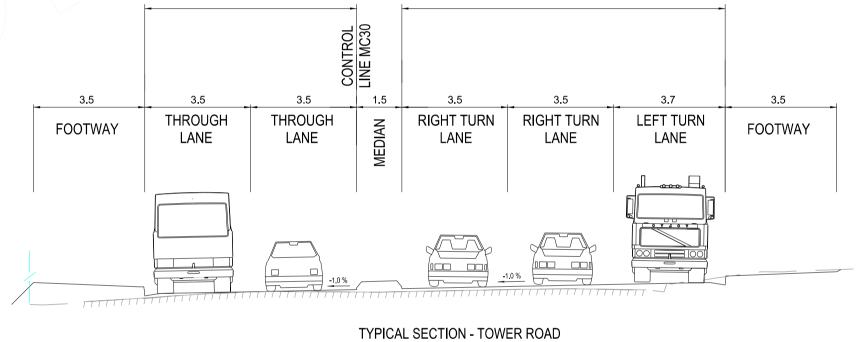
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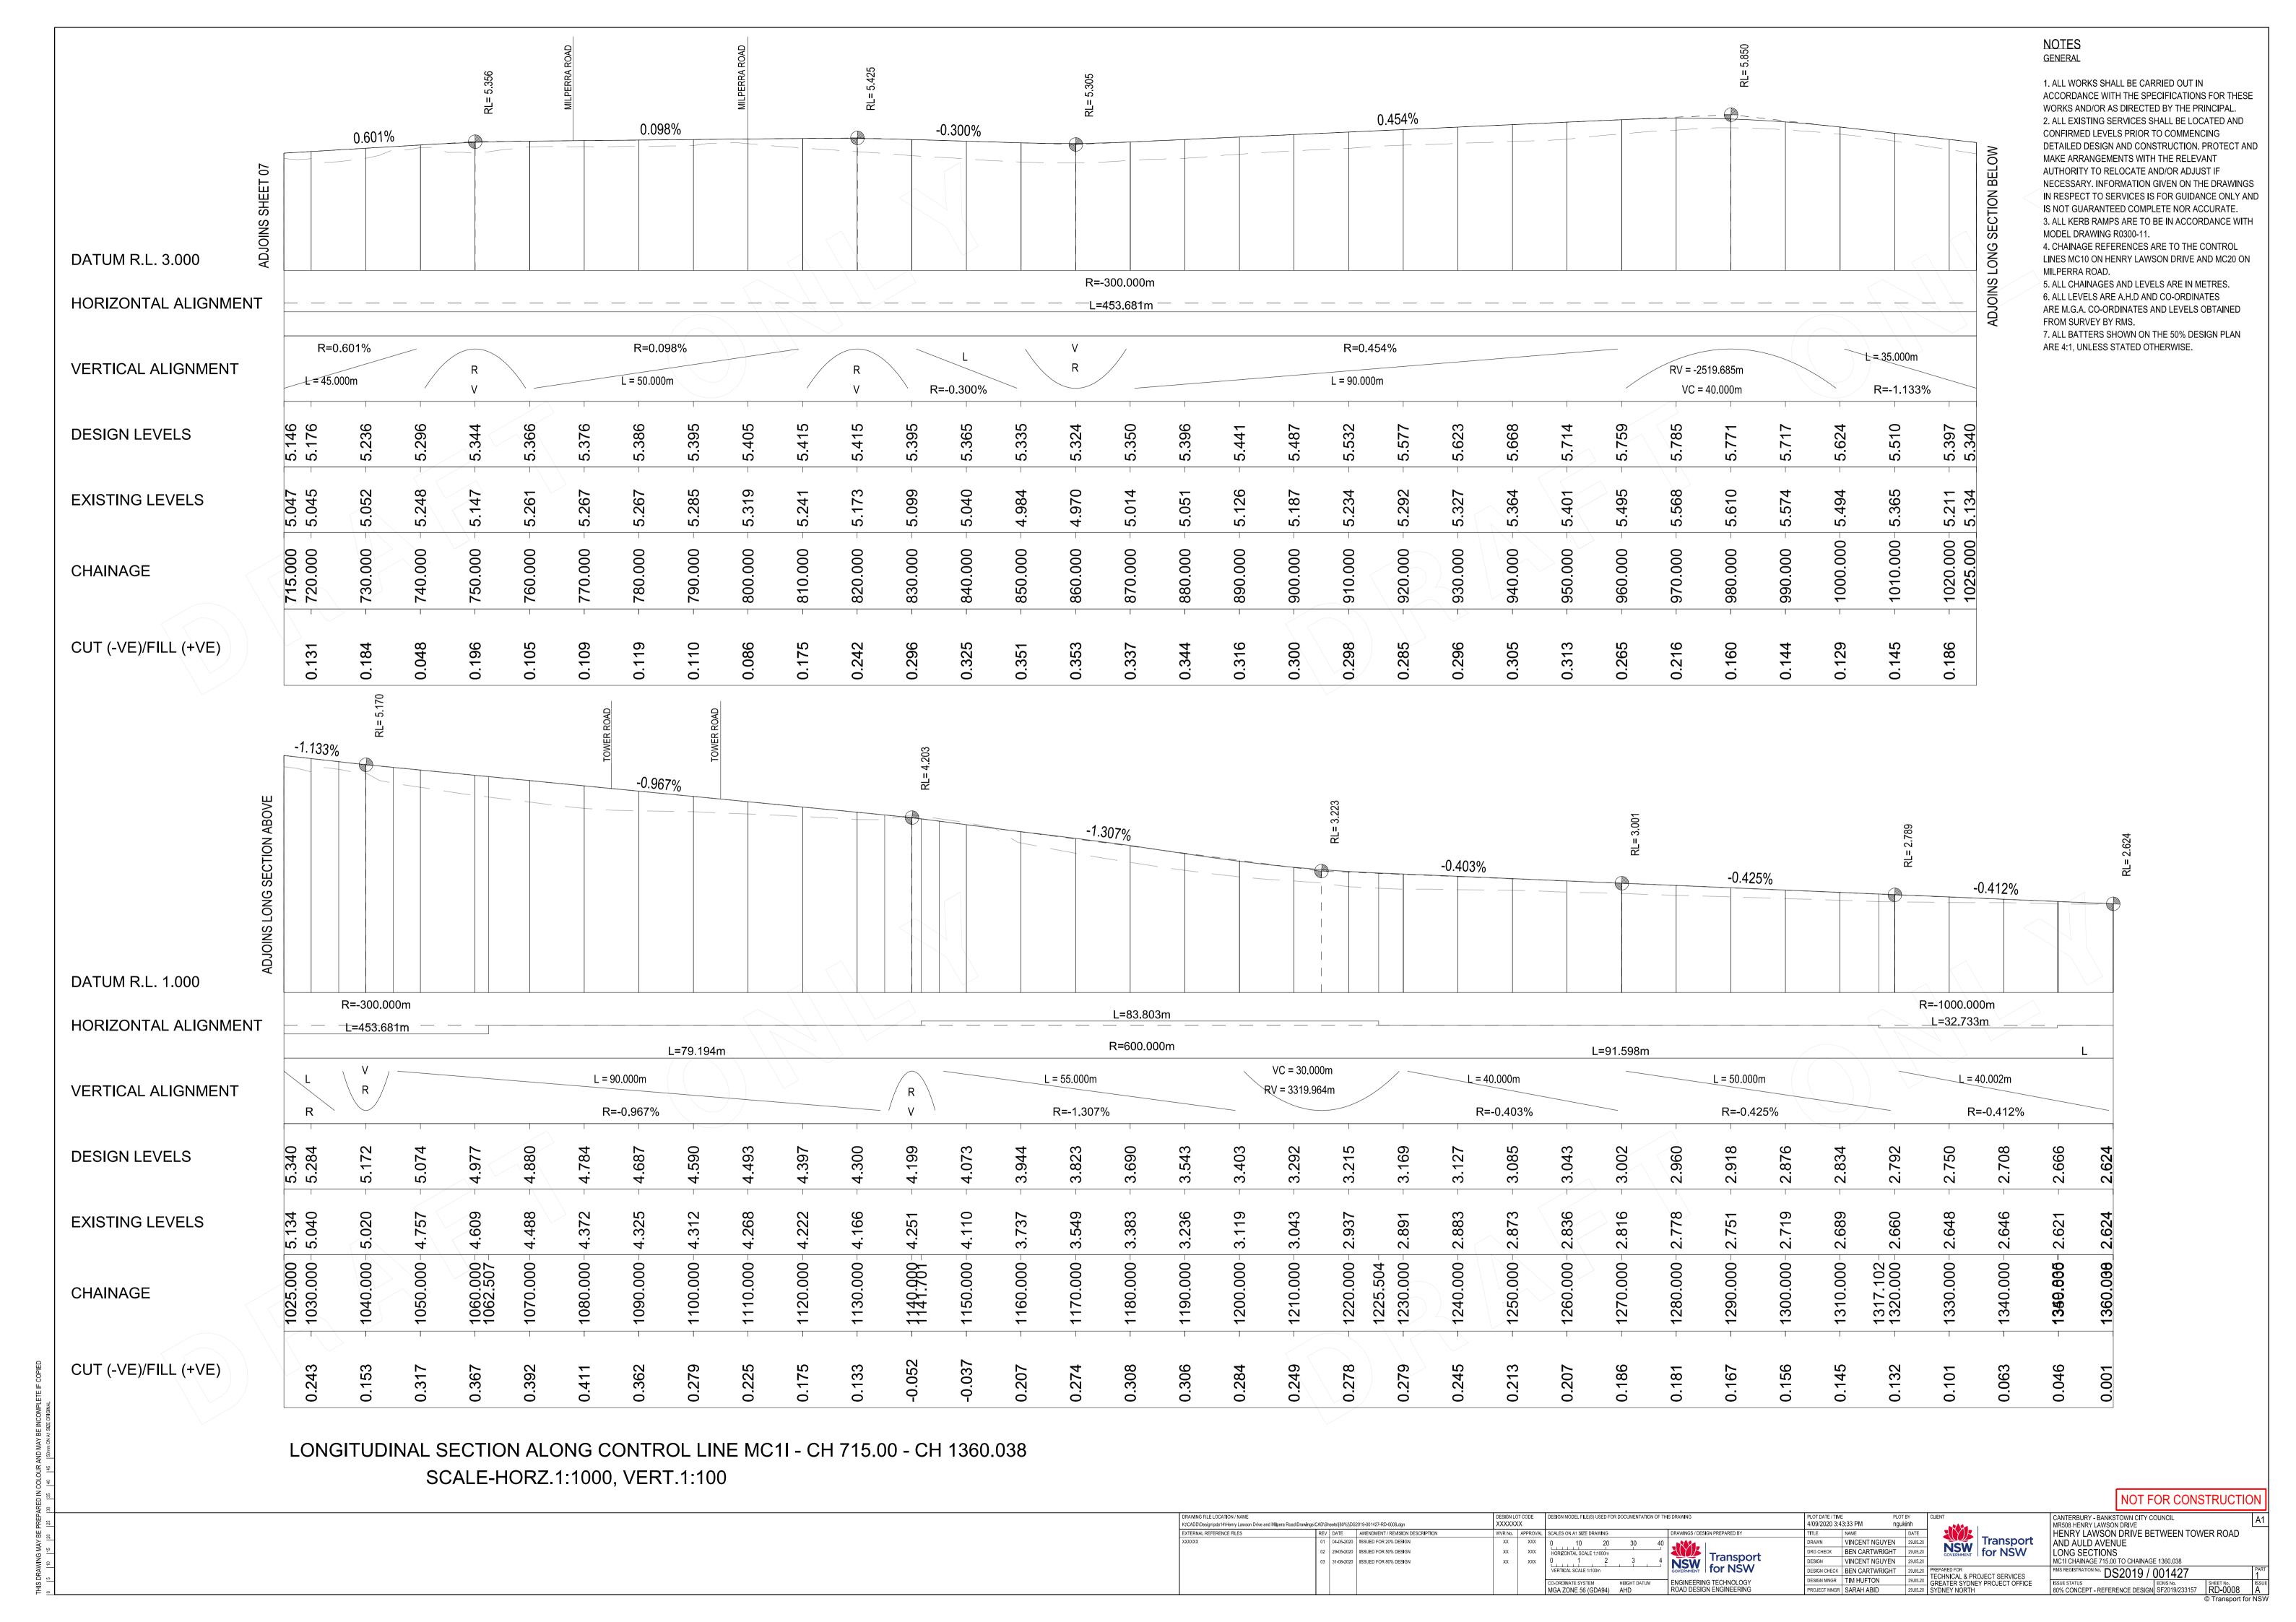




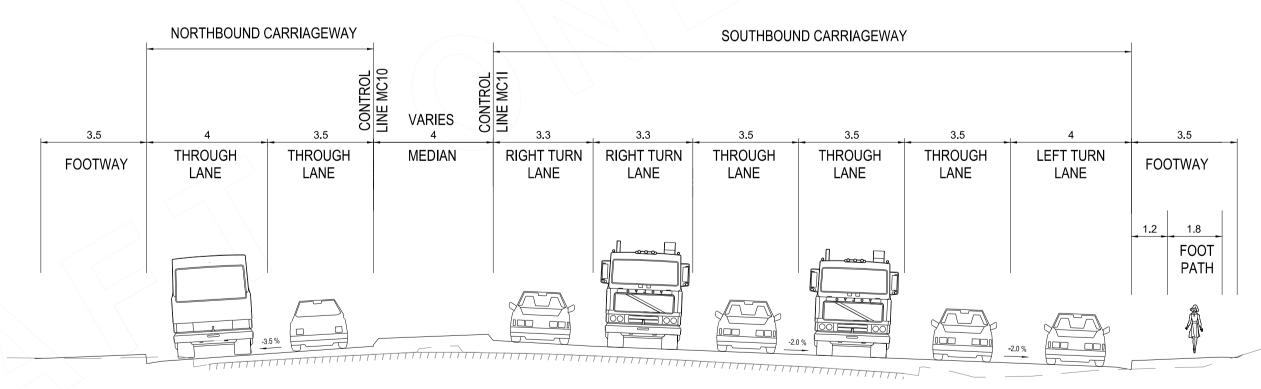


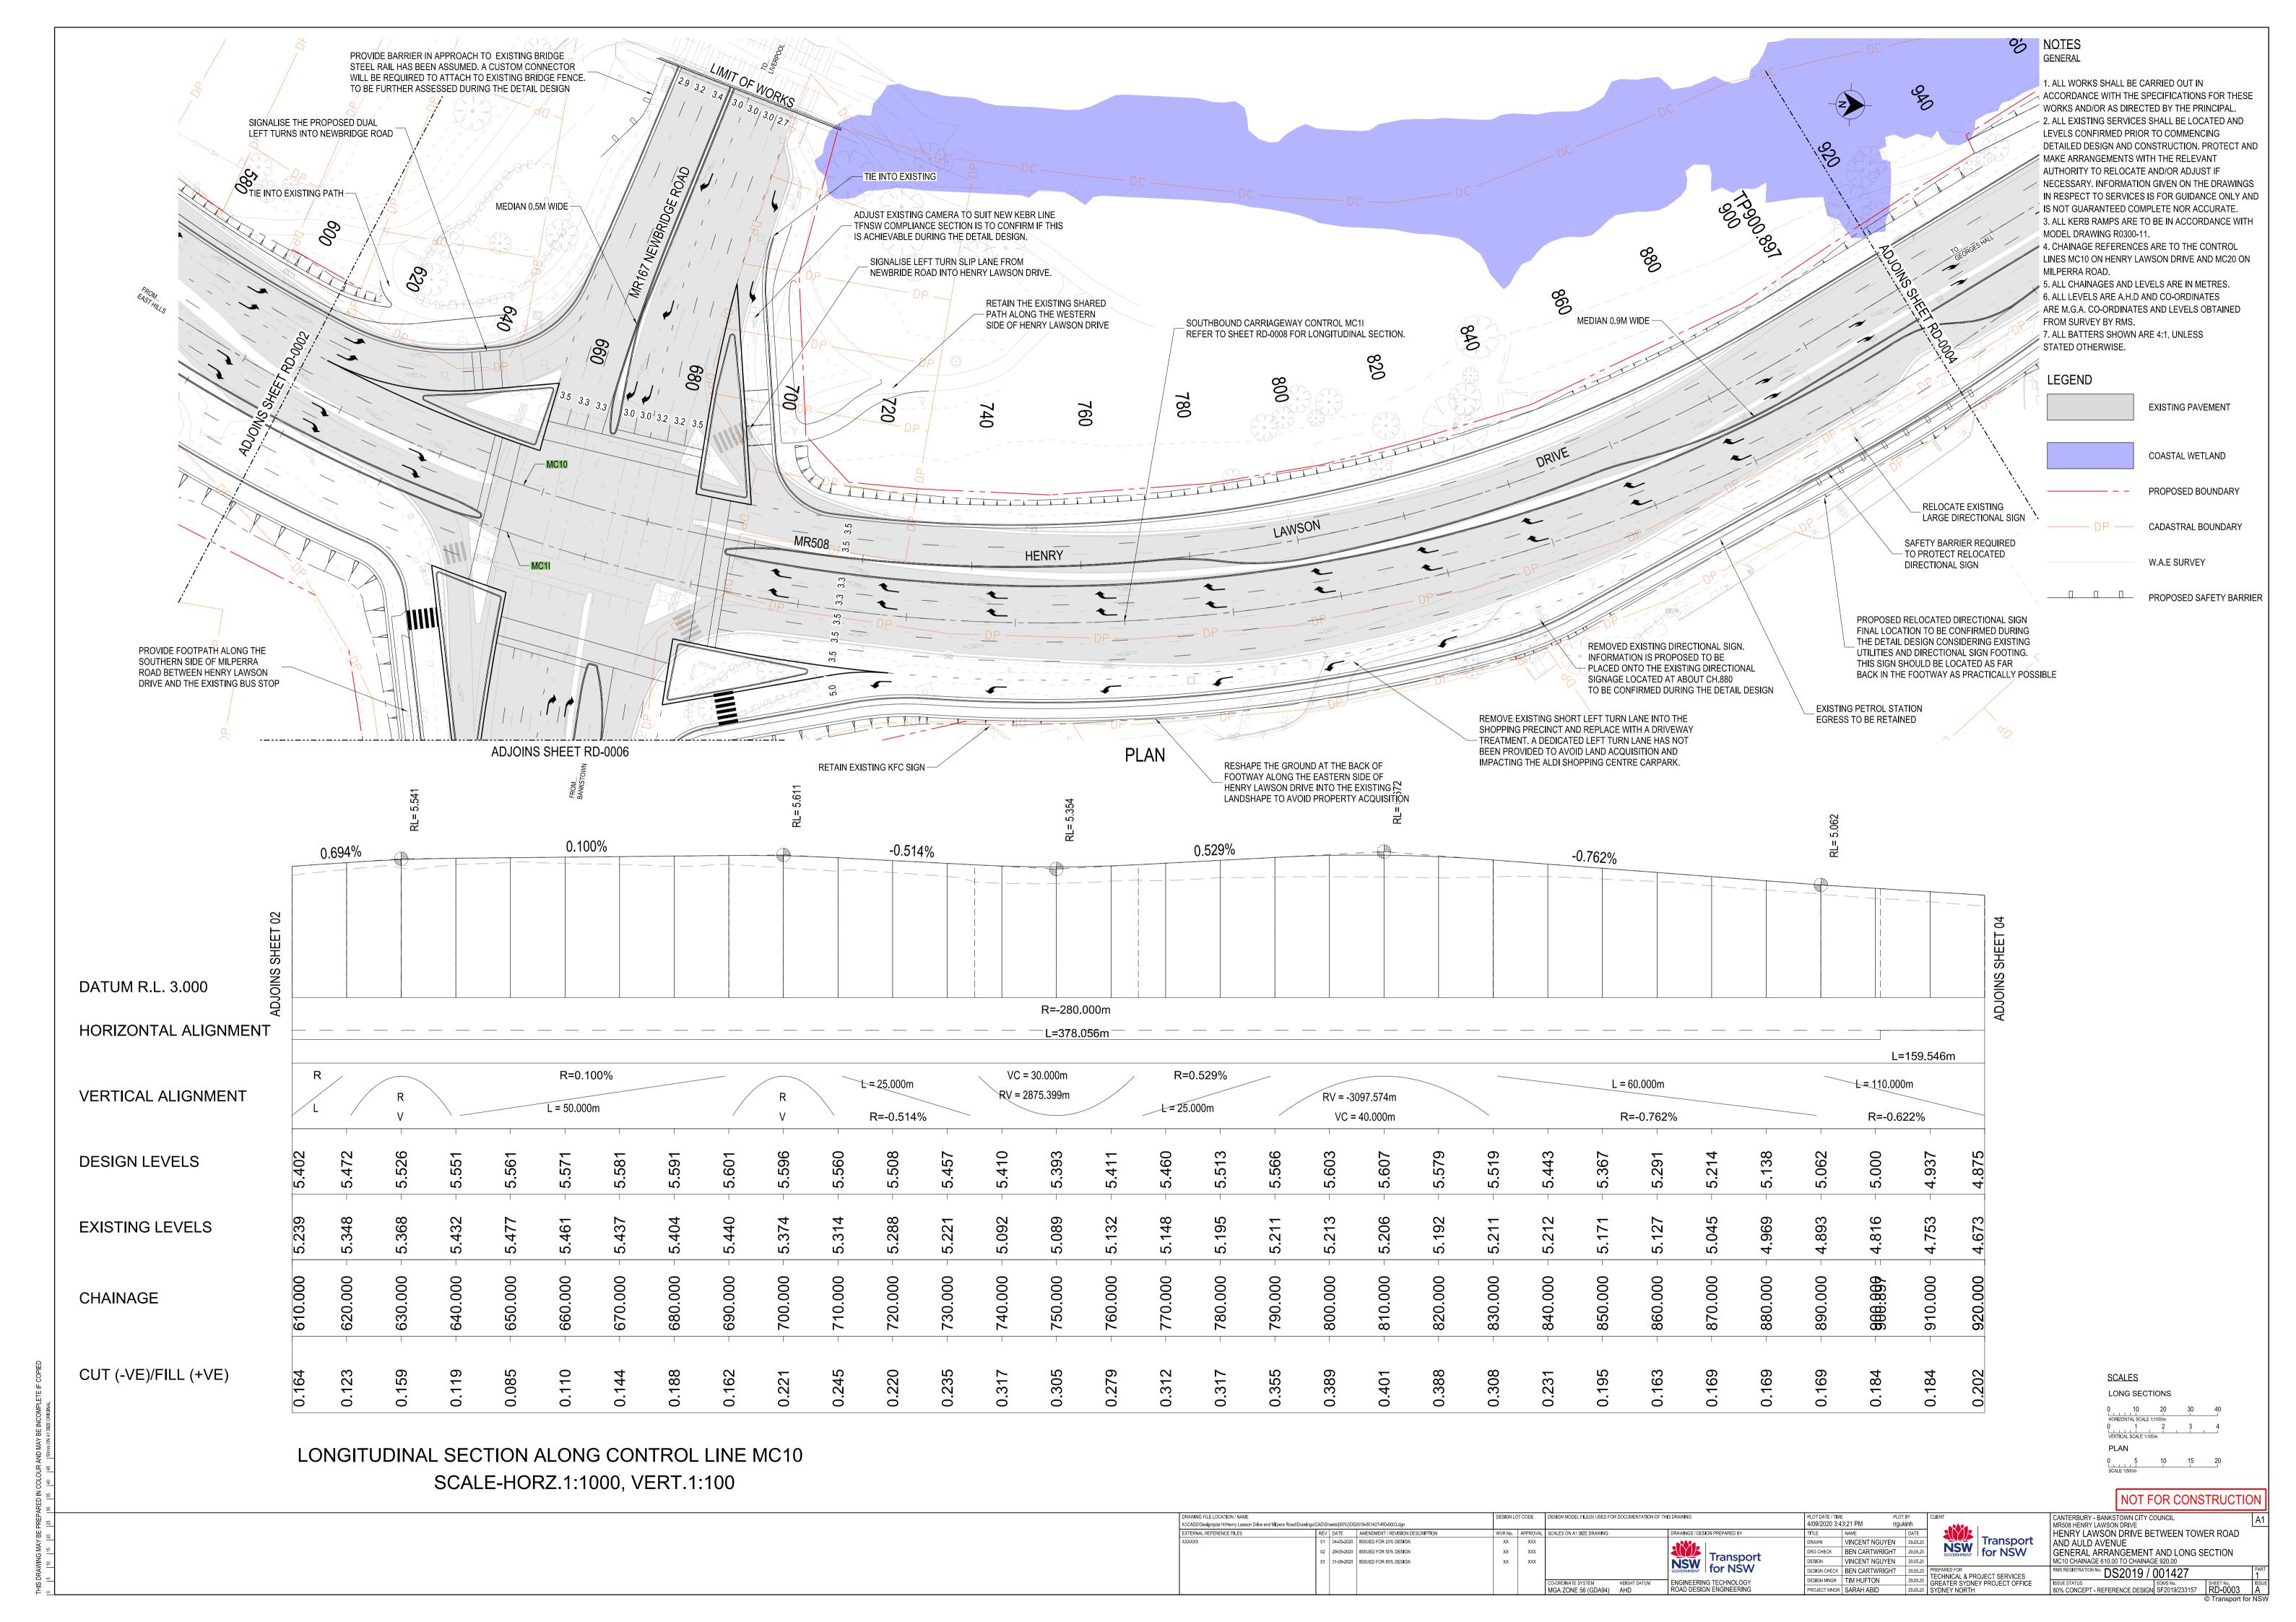

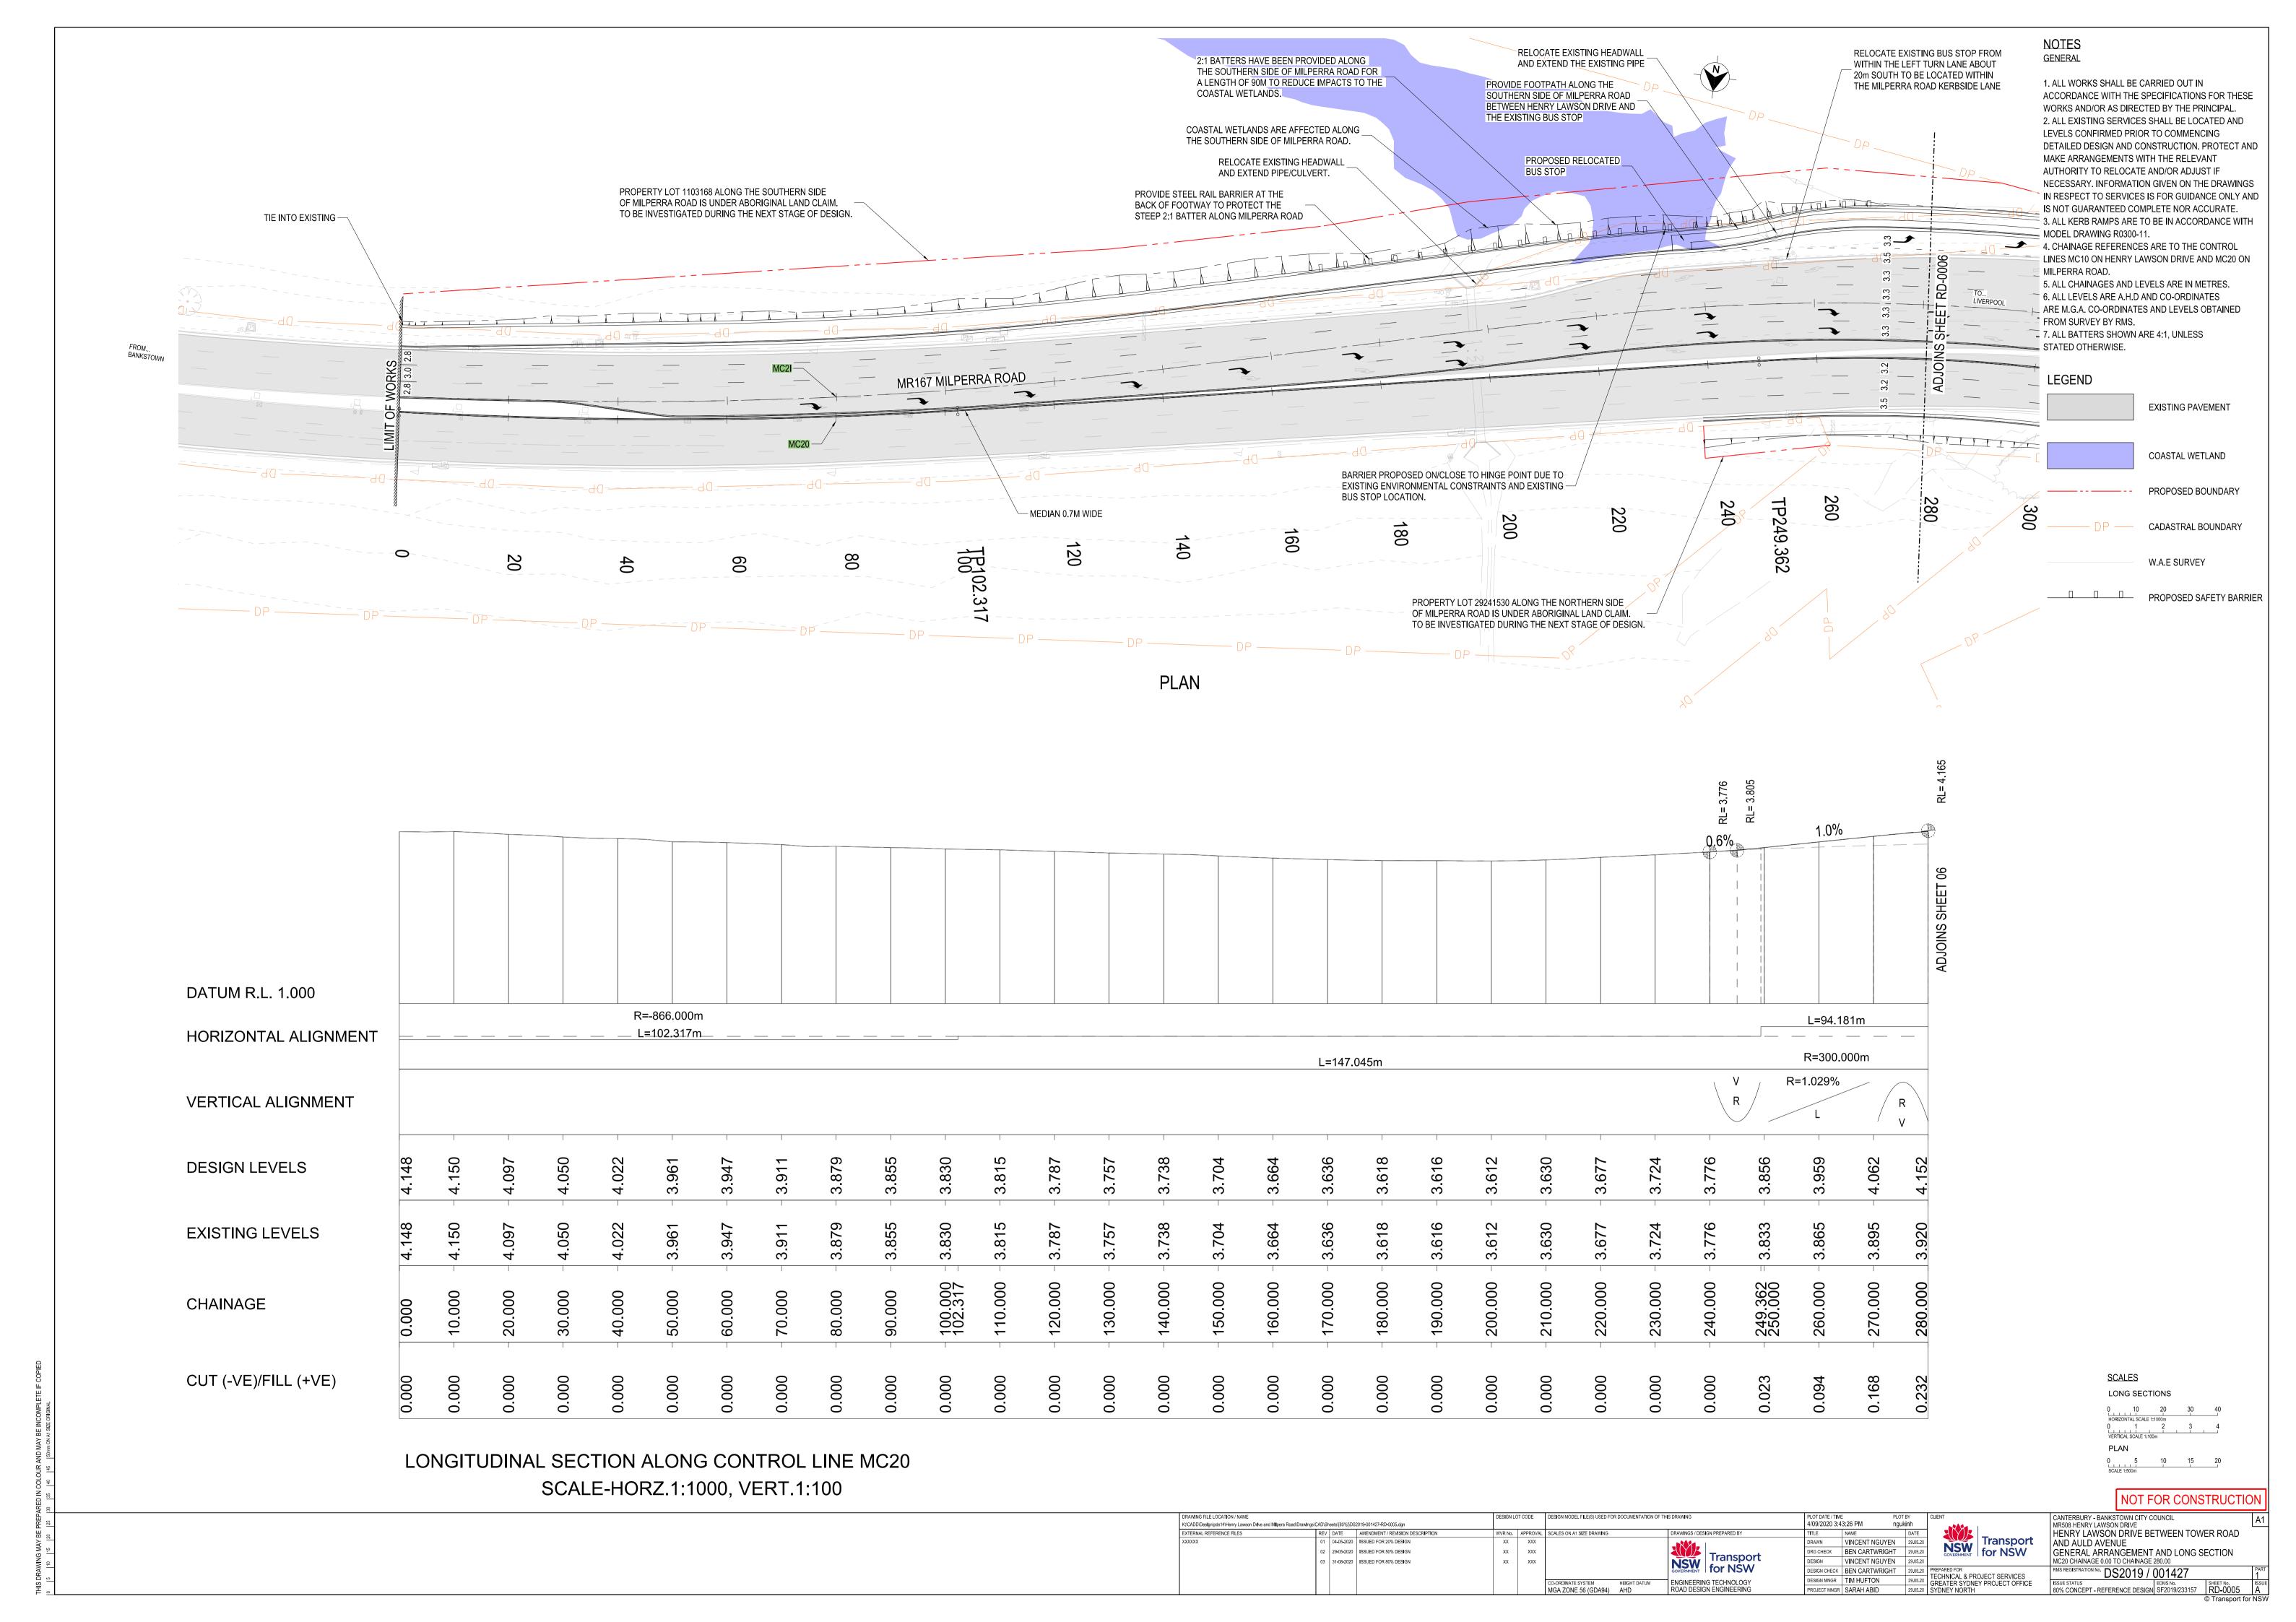


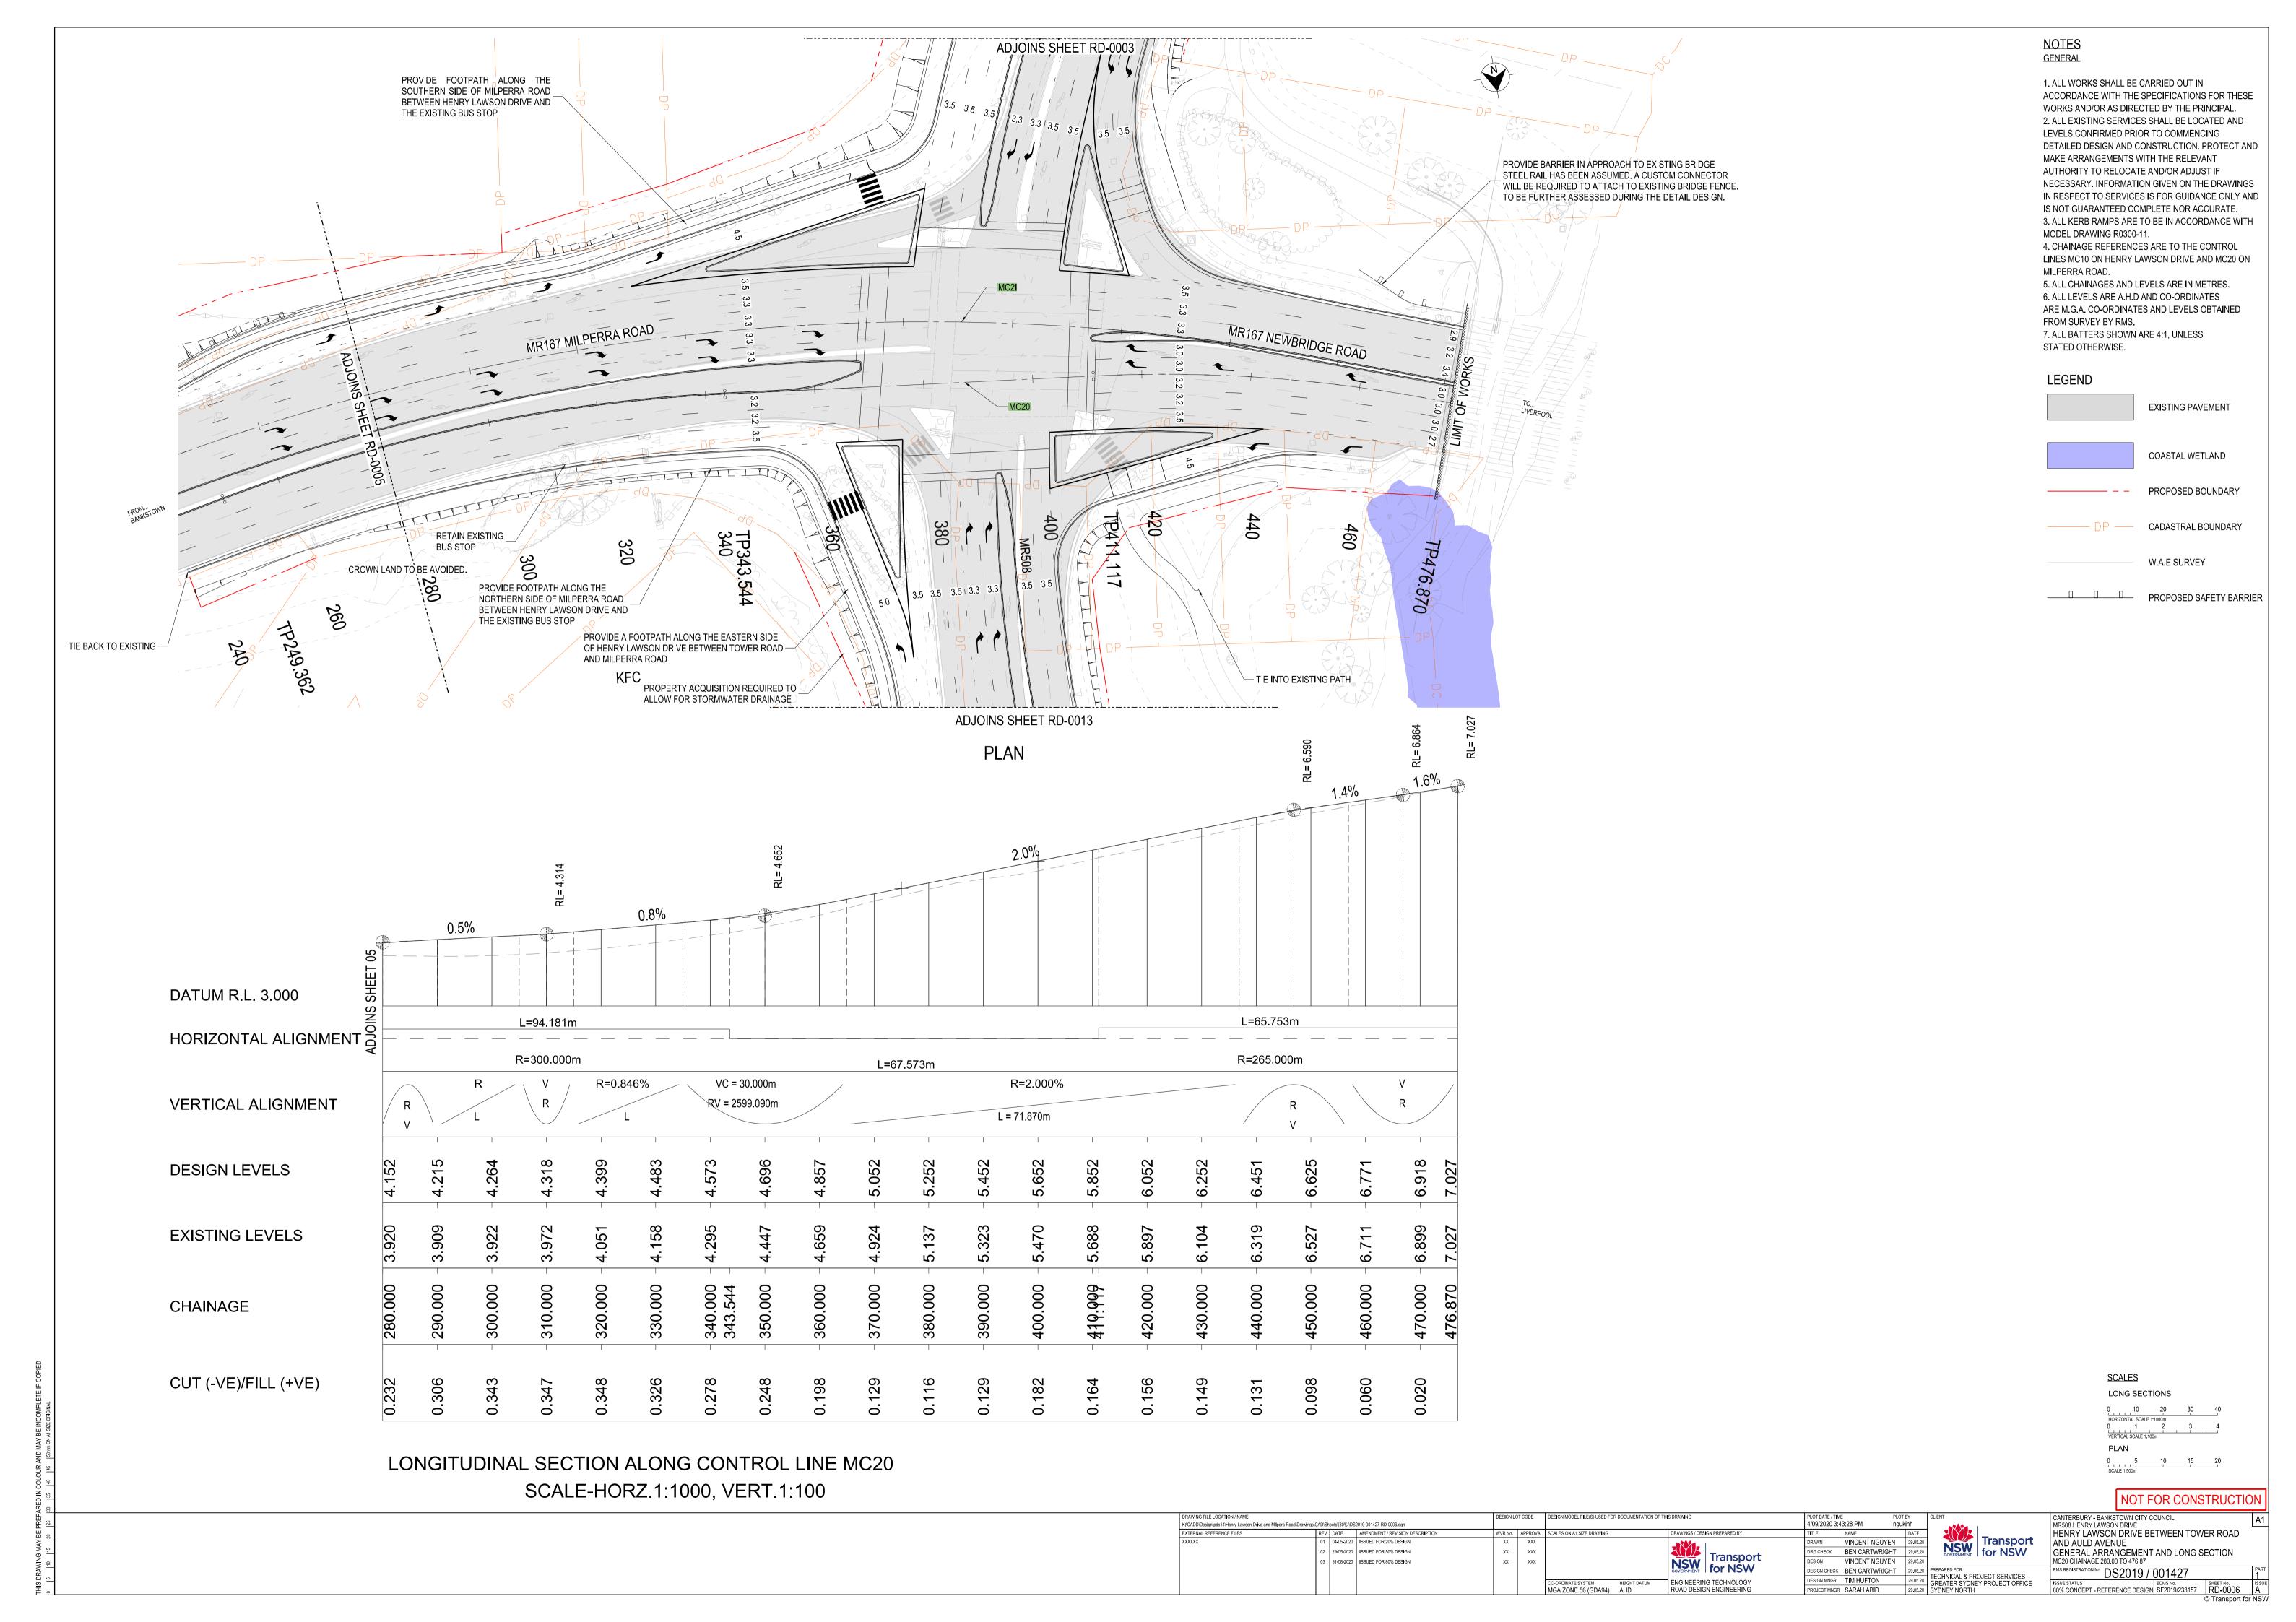


GEORGES RIVER

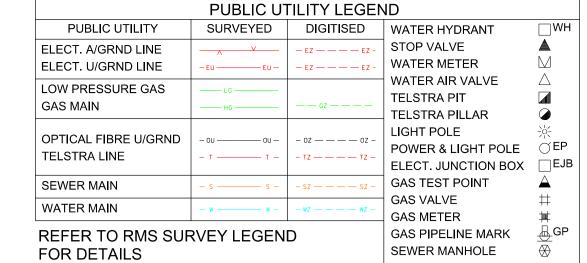



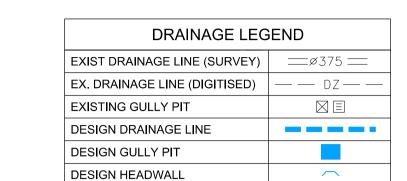

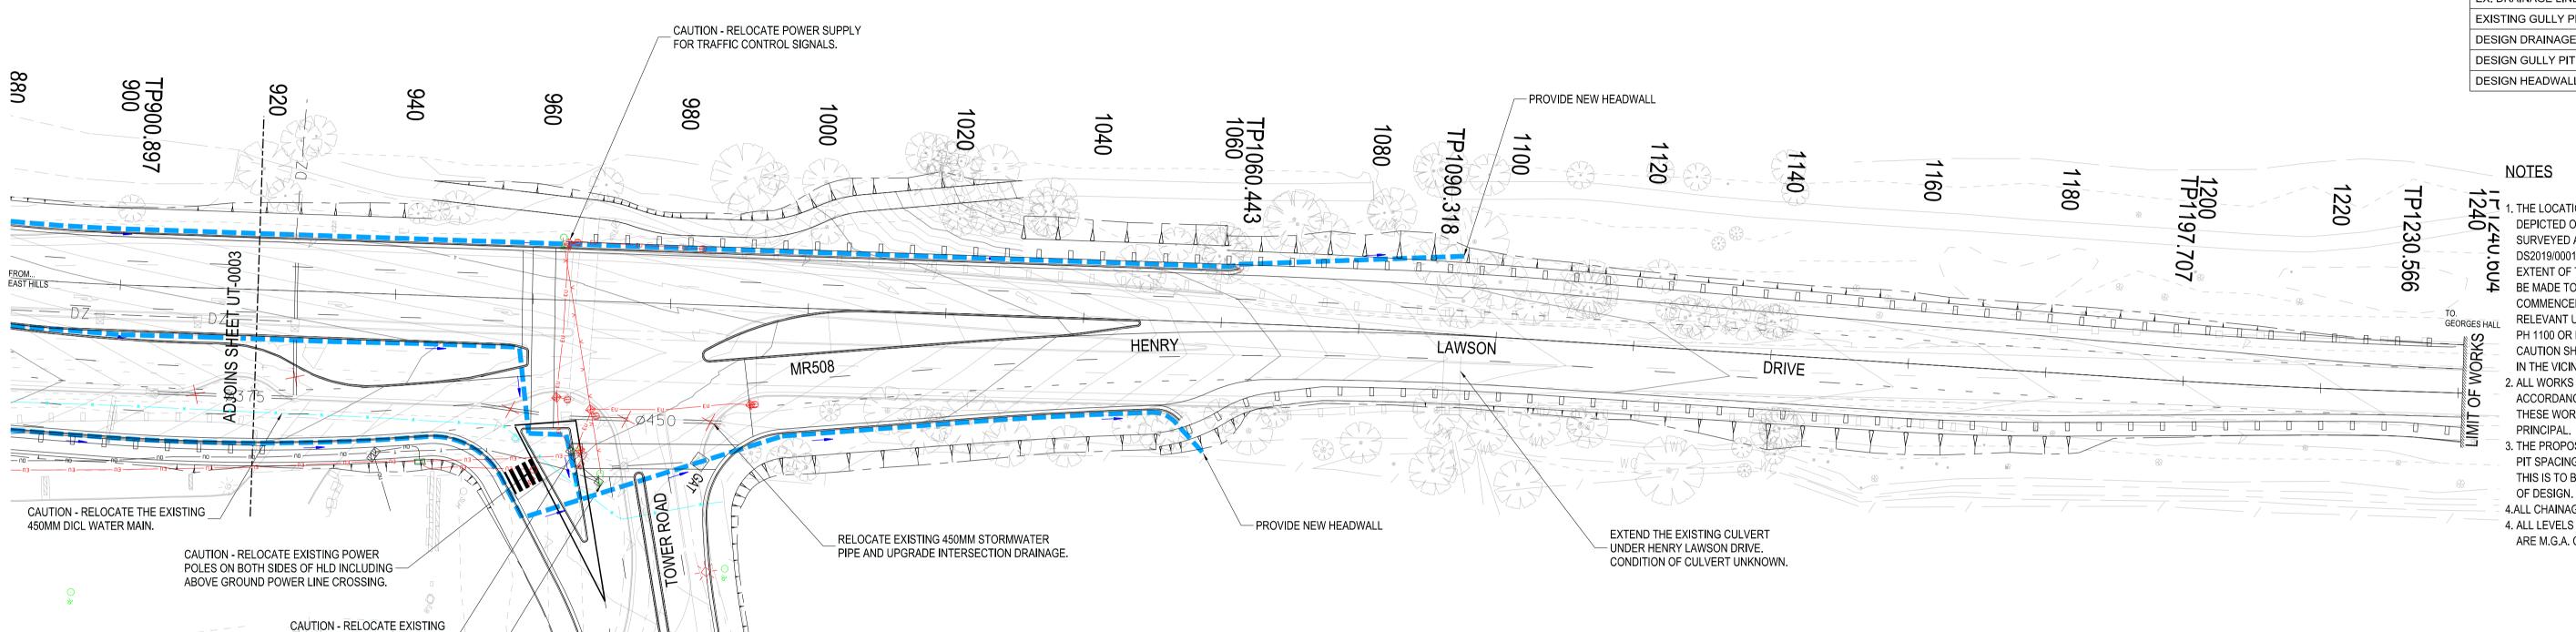

TRAFFIC SIGNAL CONTROLLER.

RELOCATE EXISTING POLE AND ABOVE __/
GROUND COMMUNICATION CABLE

1. THE LOCATION OF SERVICES AT THE SITE
DEPICTED ON THIS PLAN HAVE BEEN PARTIALLY
SURVEYED AND ARE SHOWN ON DRAWING
DS2019/000185. TO DETERMINE THE NATURE AND
EXTENT OF THIS SURVEY WORK, REFERENCE MUST
BE MADE TO THIS DRAWING PRIOR TO THE
COMMENCEMENT OF ROADWORKS, AND THE
RELEVANT UTILITY PLANS OBTAINED BY DIALLING
PH 1100 OR FAX 1300652077 (DIAL BEFORE YOU DIG).
CAUTION SHOULD BE EXERCISED WHEN WORKING
IN THE VICINITY OF ALL UTILITY SERVICES.
2. ALL WORKS SHALL BE CARRIED OUT IN
ACCORDANCE WITH THE SPECIFICATIONS FOR
THESE WORKS AND/OR AS DIRECTED BY THE

PRINCIPAL.

3. THE PROPOSED DRAINAGE DESIGN HAS ASSUMED A PIT SPACING OF 20M (PITS NOT SHOWN ON PLAN).

THIS IS TO BE ASSESSED DURING THE NEXT STAGE

4. ALL LEVELS ARE A.H.D AND CO-ORDINATES

4. ALL LEVELS ARE A.H.D AND CO-ORDINATES ARE M.G.A. CO-ORDINATES.

NOT FOR CONSTRUCTION

AL SCALES ON A1 SIZE DRAWING

0 5 10 15 20
SCALE 1:500m

CO-ORDINATE SYSTEM

DRAWINGS / DESIGN PREPARED BY

Transport for NSW
ENGINEERING TECHNOLOGY

PLOT DATE / TIME
4/09/2020 3:42:04 PM
ngukinh

TITLE
NAME
DATE
DRAWN
VINCENT NGUYEN
04.05.20
DESIGN
DESIGN CHECK
DESIGN CHECK
DESIGN CHECK
DESIGN TIM HUFTON
DESIGN NNGR
TIM HUFTON
04.05.20
PROJECT MNGR
SARAH ABID
04.05.20
CLIENT
Transport
FOR NSW

PREPARED FOR
TECHNICAL & PROJECT SERVICES
GREATER SYDNEY PROJECT OFFICE
SYDNEY NORTH

Transport for NSW

CANTERBURY - BANKSTOWN CITY COUNCIL MR508 HENRY LAWSON DRIVE
HENRY LAWSON DRIVE BETWEEN TOWER
ROAD AND AULD AVENUE
UTILITIES AND STORMWATER PLAN
MC10 BETWEEN CHAINAGE 920.00 AND CHAINAGE 1240

RMS REGISTRATION No. DS2019 / 001427
ISSUE STATUS
80% CONCEPT - REFERENCE DESIGN SF2019/233157

ISSUE STATUS
80% CONCEPT - REFERENCE DESIGN SF2019/233157


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MR508 HENRY LAWSON DRIVE


A1

PART
1

SHEET NO. SHEET NO. SHEET NO. SF2019/233157

ISSUE STATUS
80% CONCEPT - REFERENCE DESIGN SF2019/233157

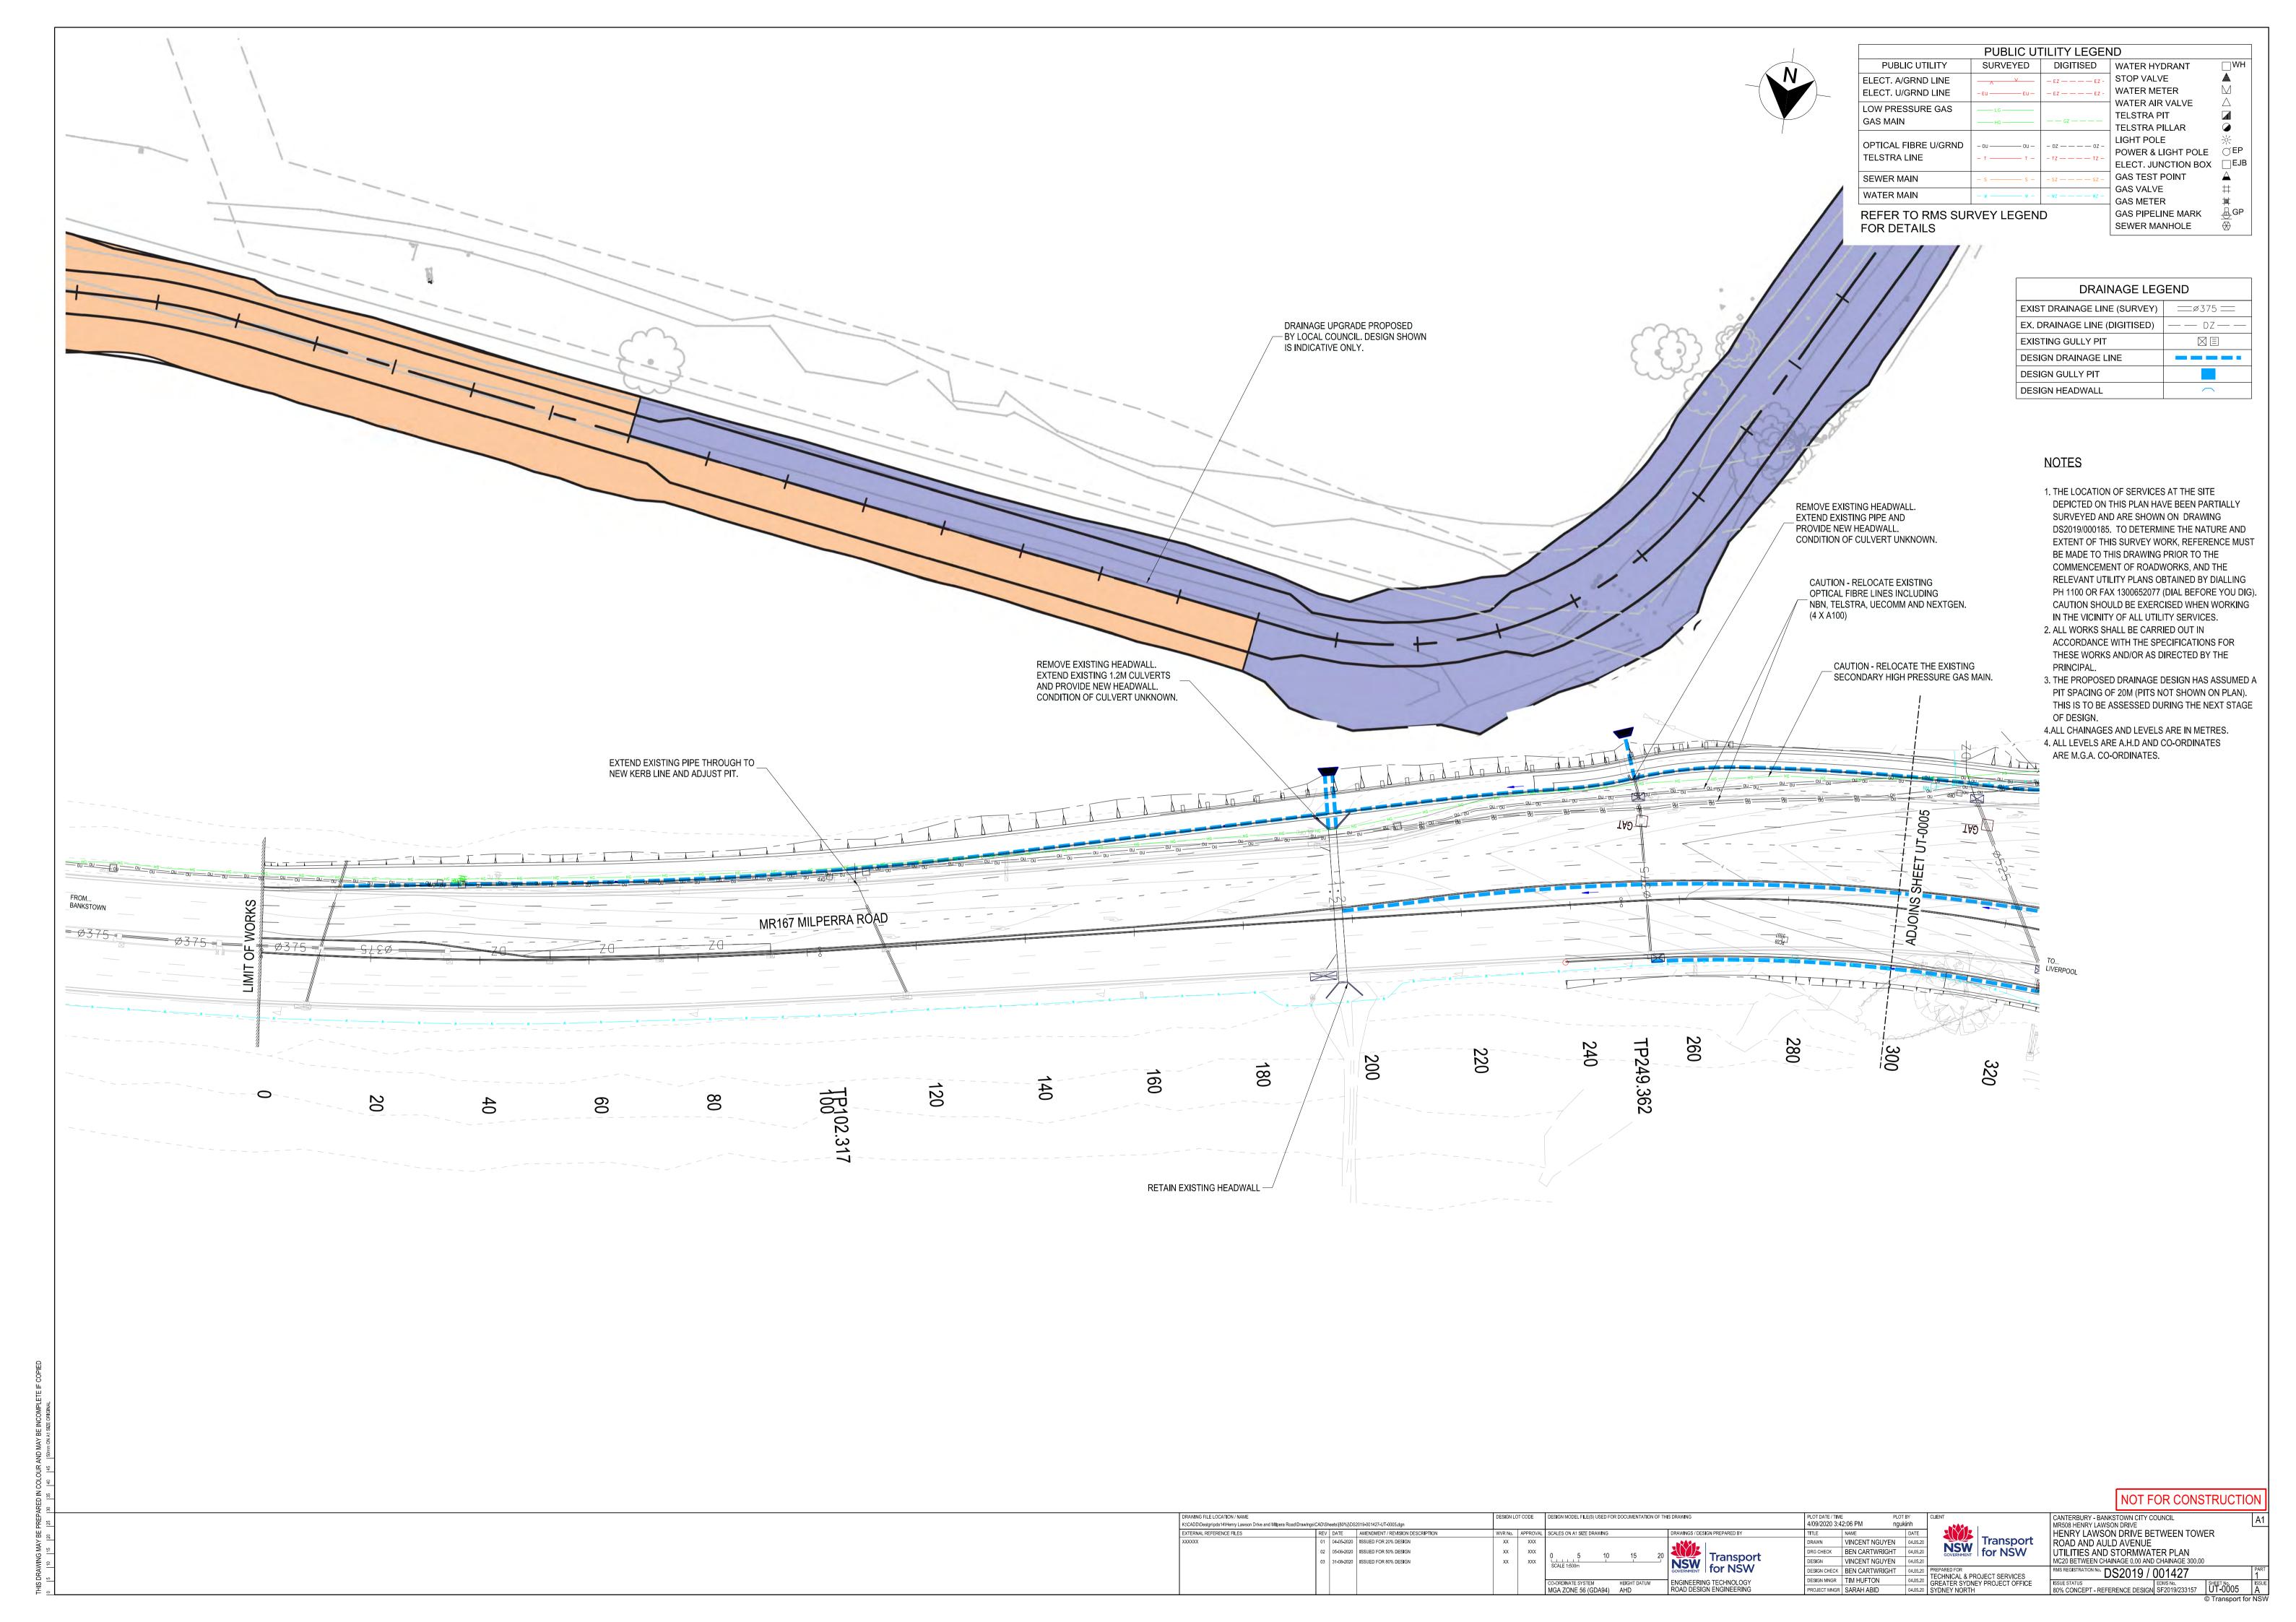

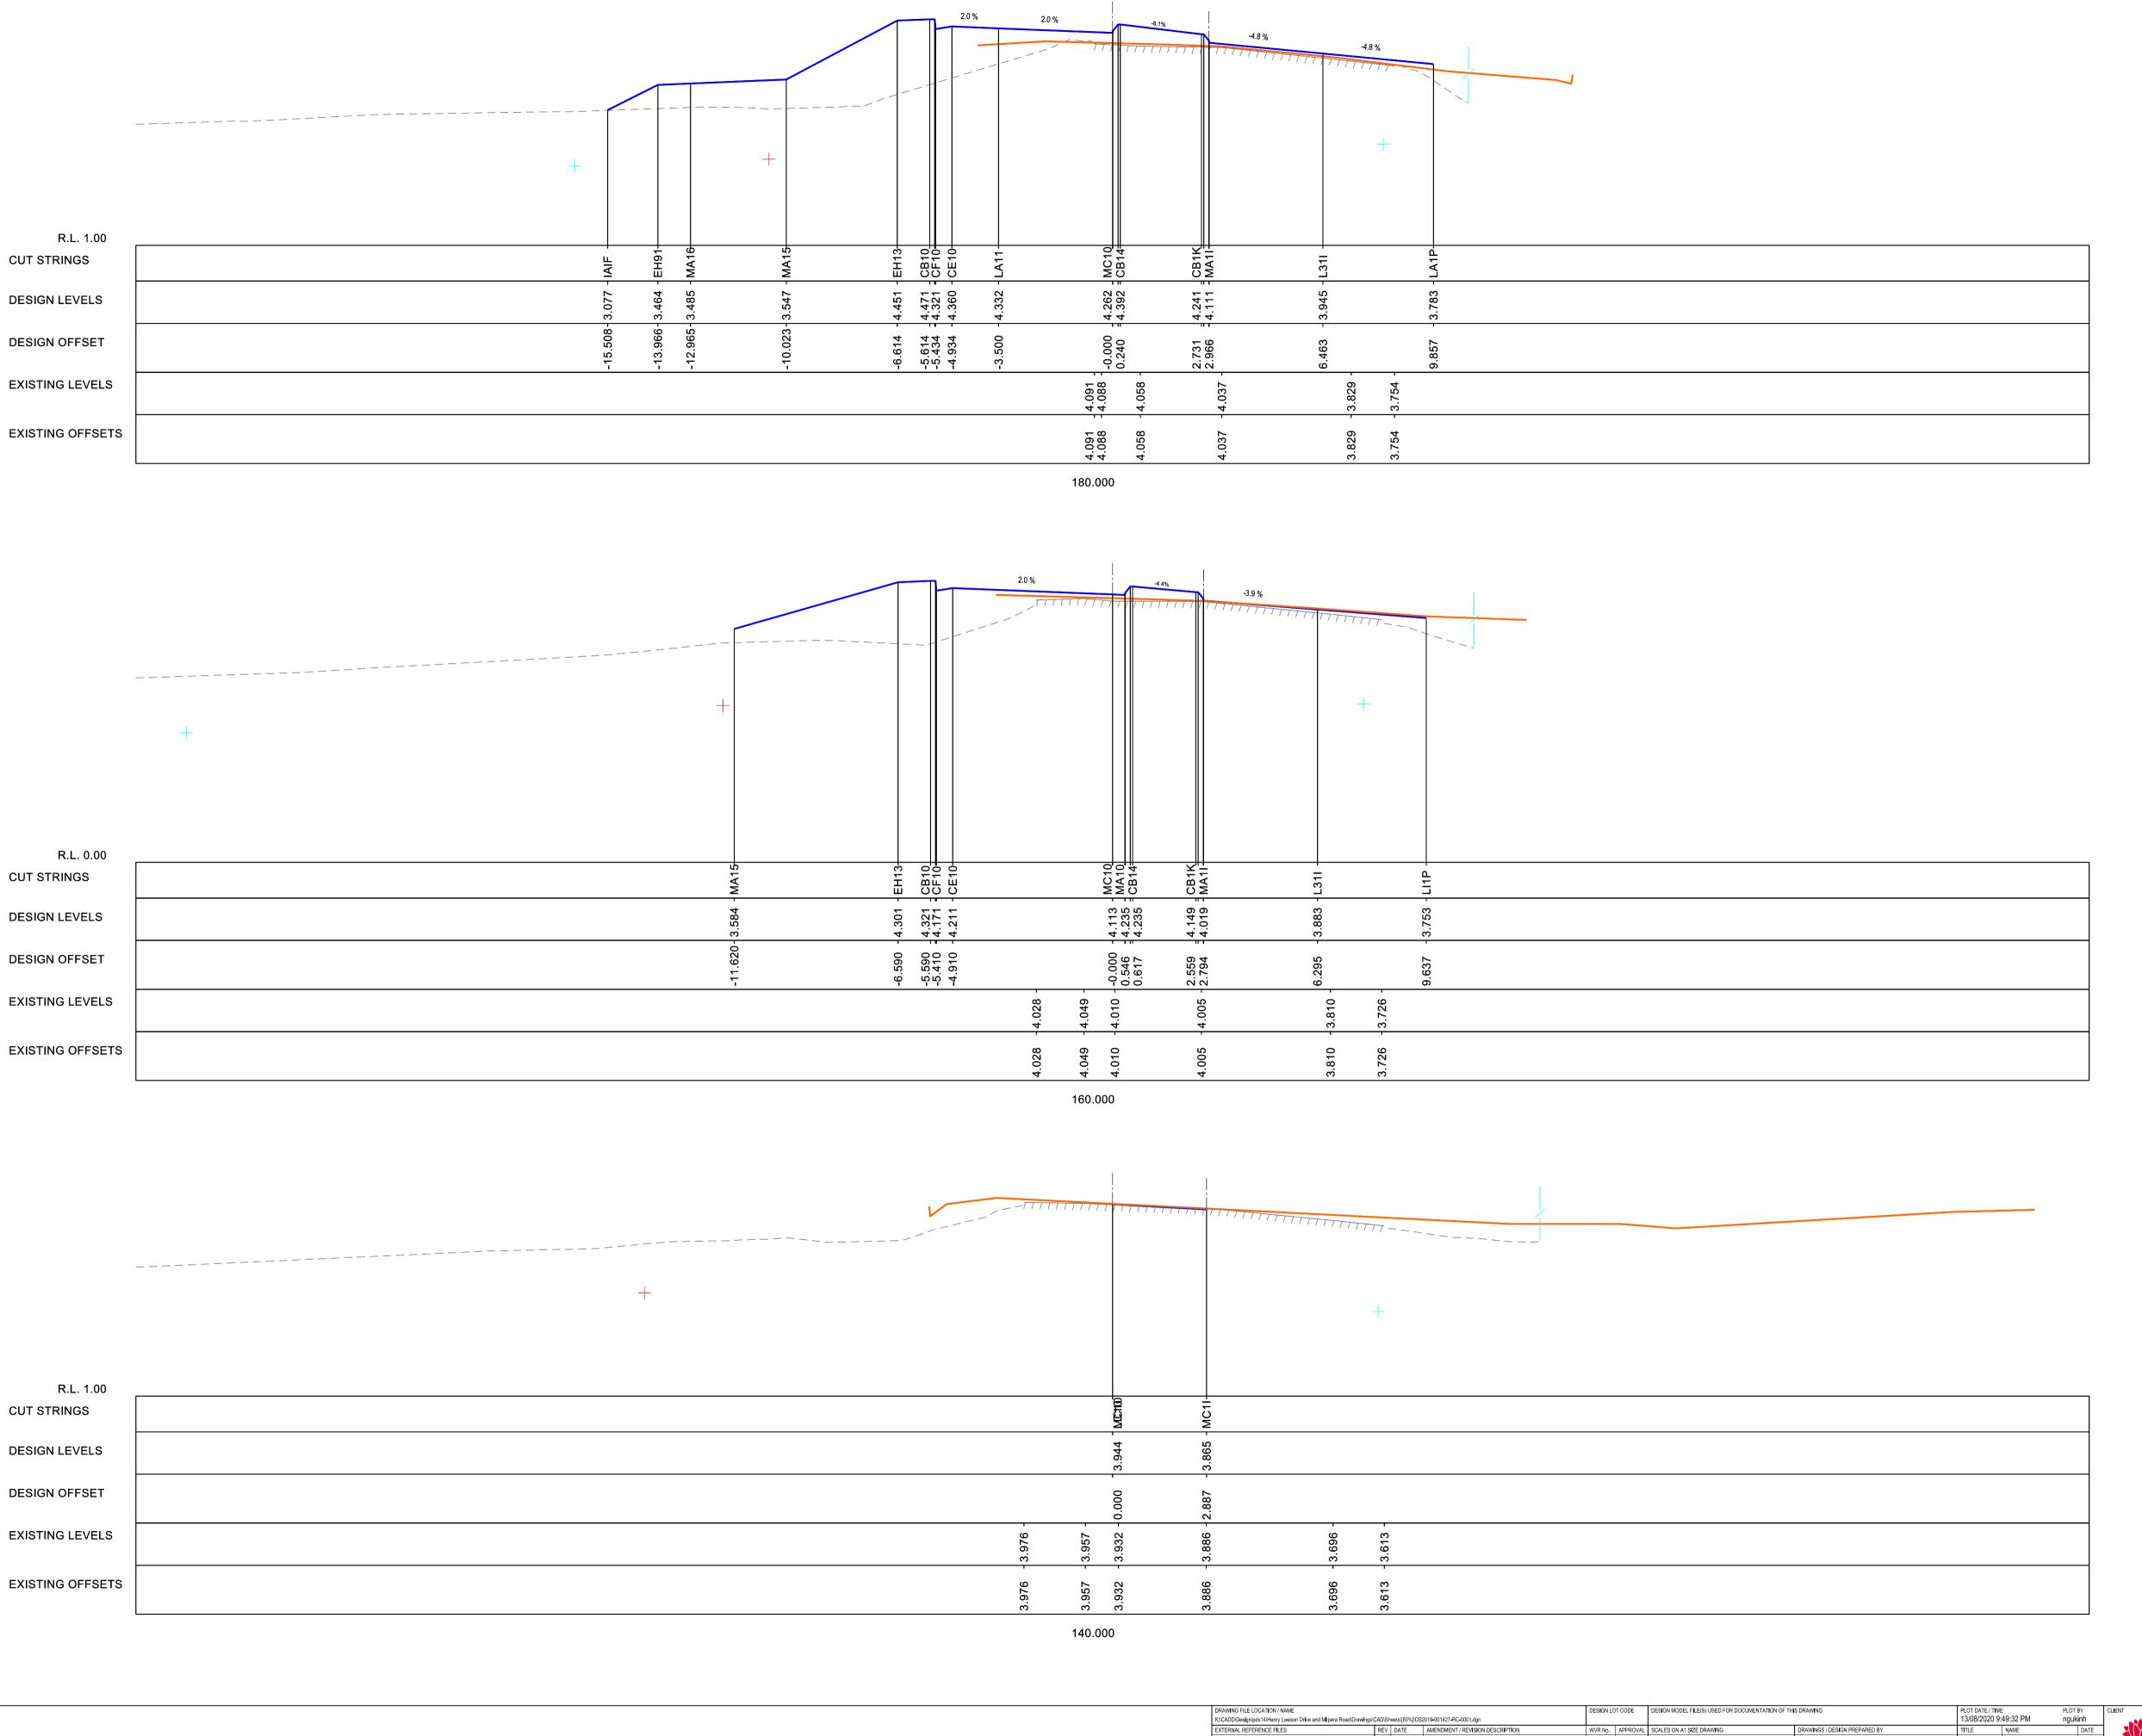

REV DATE AMENDMENT / REVISION DESCRIPTION

01 04-05-2020 ISSUED FOR 20% DESIGN 02 29-05-2020 ISSUED FOR 50% DESIGN 02 31-08-2020 ISSUED FOR 80% DESIGN CO-ORDINATE SYSTEM HEIGHT DATUM MGA ZONE 56 (GDA94) AHD

NOT FOR CONSTRUCTION CANTERBURY - BANKSTOWN CITY COUNCIL
MR508 HENRY LAWSON DRIVE
HENRY LAWSON DRIVE BETWEEN TOWER ROAD
AND AULD AVENUE
CROSS SECTIONS - HENRY LAWSON DRIVE MC10
MC10 - CHAINAGE 140.00 TO CHAINAGE 180.00

RMS REGISTRATION NO.
DS2019 / 001427

ISSUE STATUS
80% CONCEPT - REFERENCE DESIGN | SF2019/233157 | SHEET NO. | ISSUE
RC-00001 | A

Transport for NSW TITLE NAME DATE
DRAWN VINCENT NGUYEN 29.05.20
DRG CHECK BEN CARTWRIGHT 29.05.20
DESIGN VINCENT NGUYEN 29.05.20
DESIGN CHECK BEN CARTWRIGHT 29.05.20
DESIGN MNGR TIM HUFTON 29.05.20
PROJECT MNGR SARAH ABID 29.05.20
SYDNEY NORTH

LEGEND

———— DESIGN SURFACE

EXISTING PAVEMENT

— — — EXISTING SURFACE

FLOWER POWER W.A.E SURFACE

EXISTING FENCE

CADASTRAL BOUNDARIES


PROPOSED BARRIERS


HIGH PRESSURE GAS


TELEPHONE

WATER MAIN

OPTICAL FIBRE UNDERGROUND

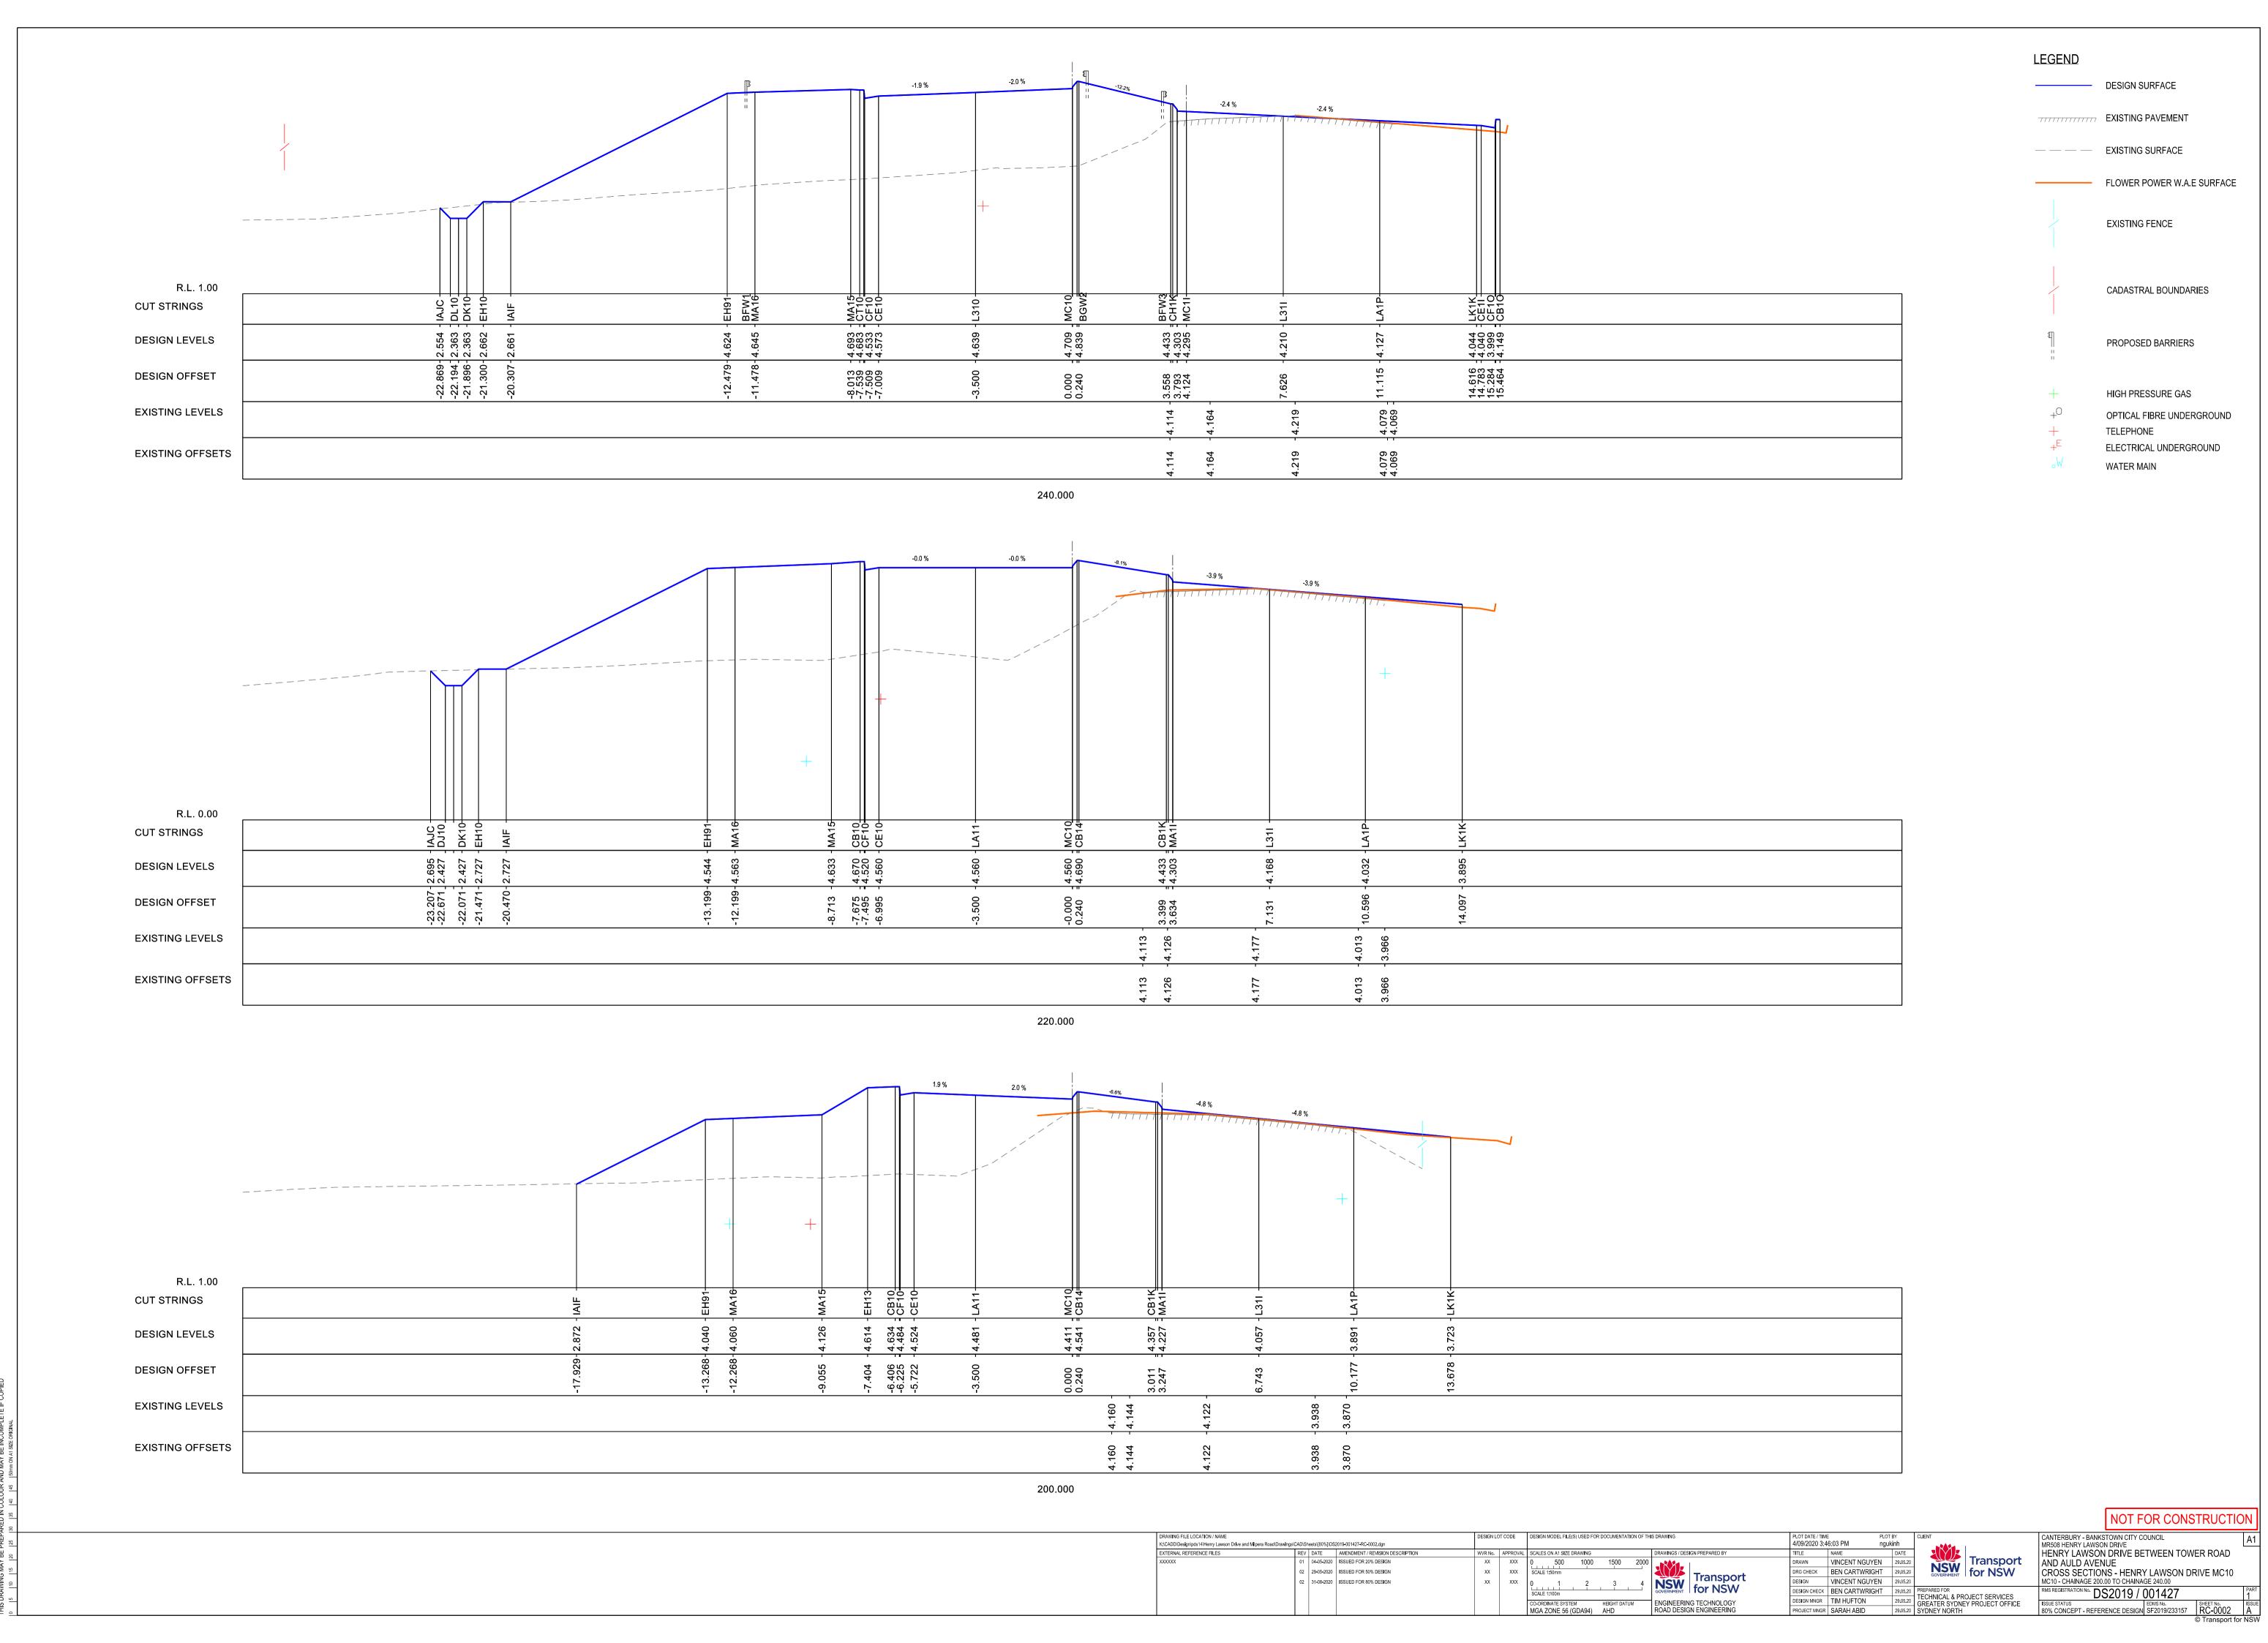

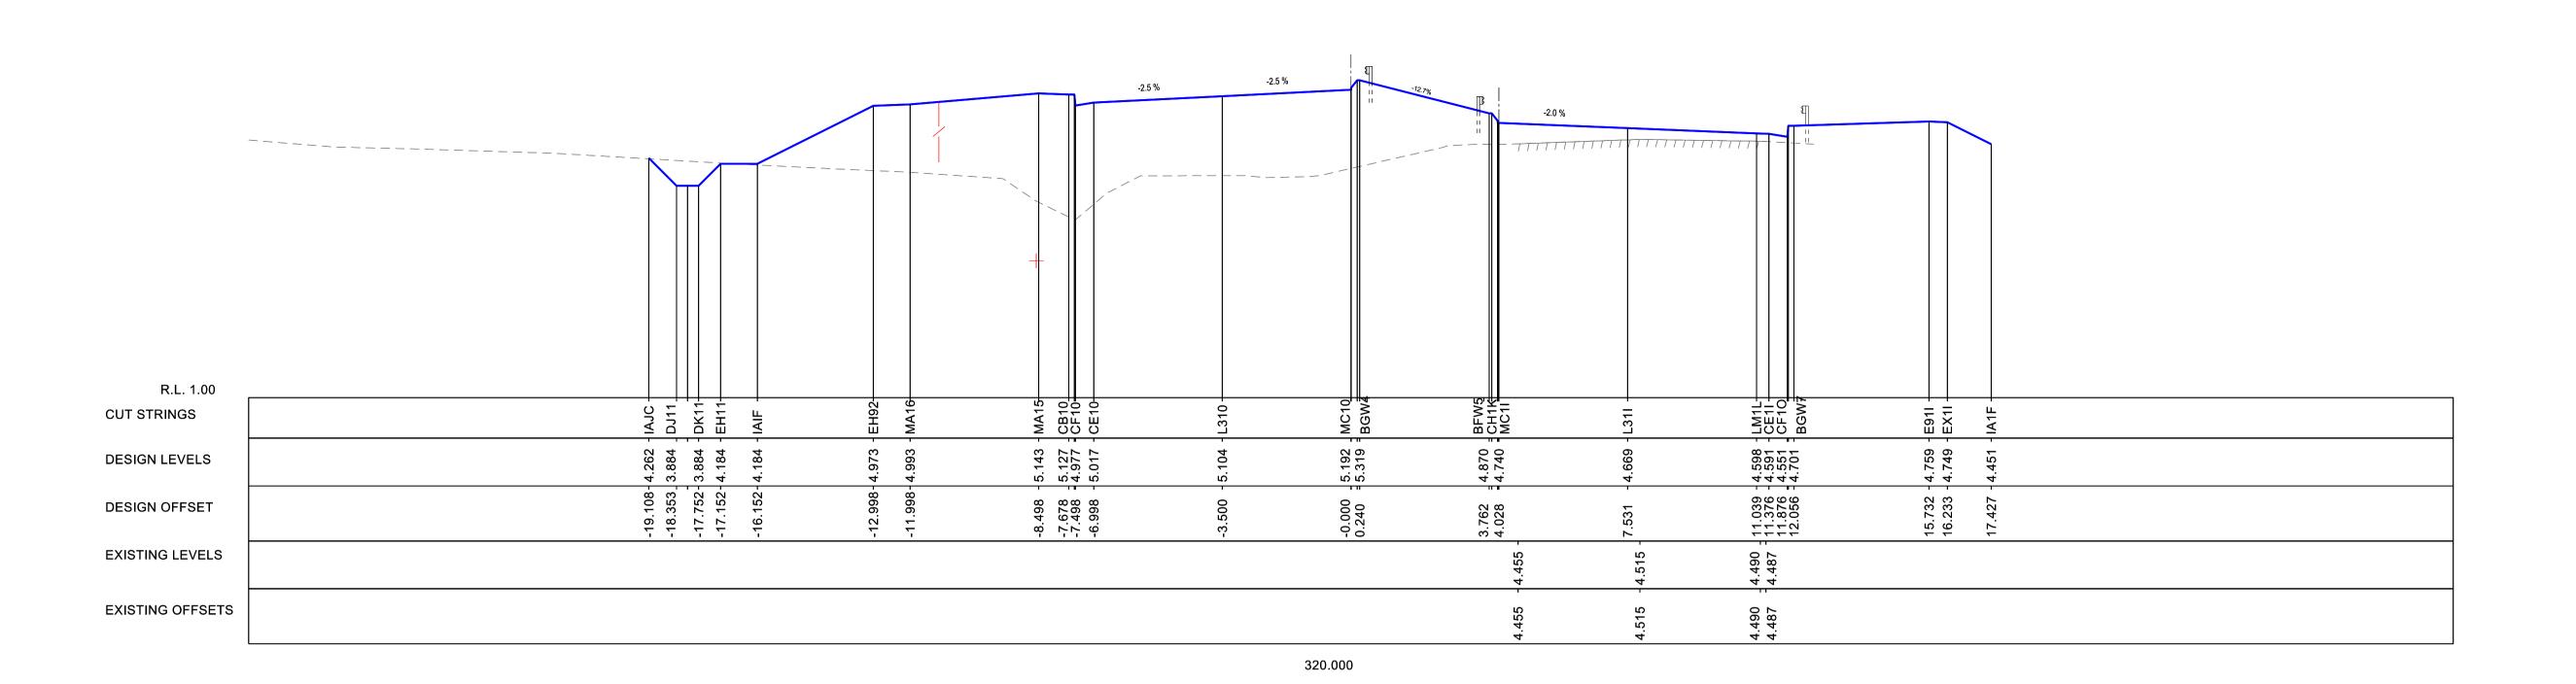

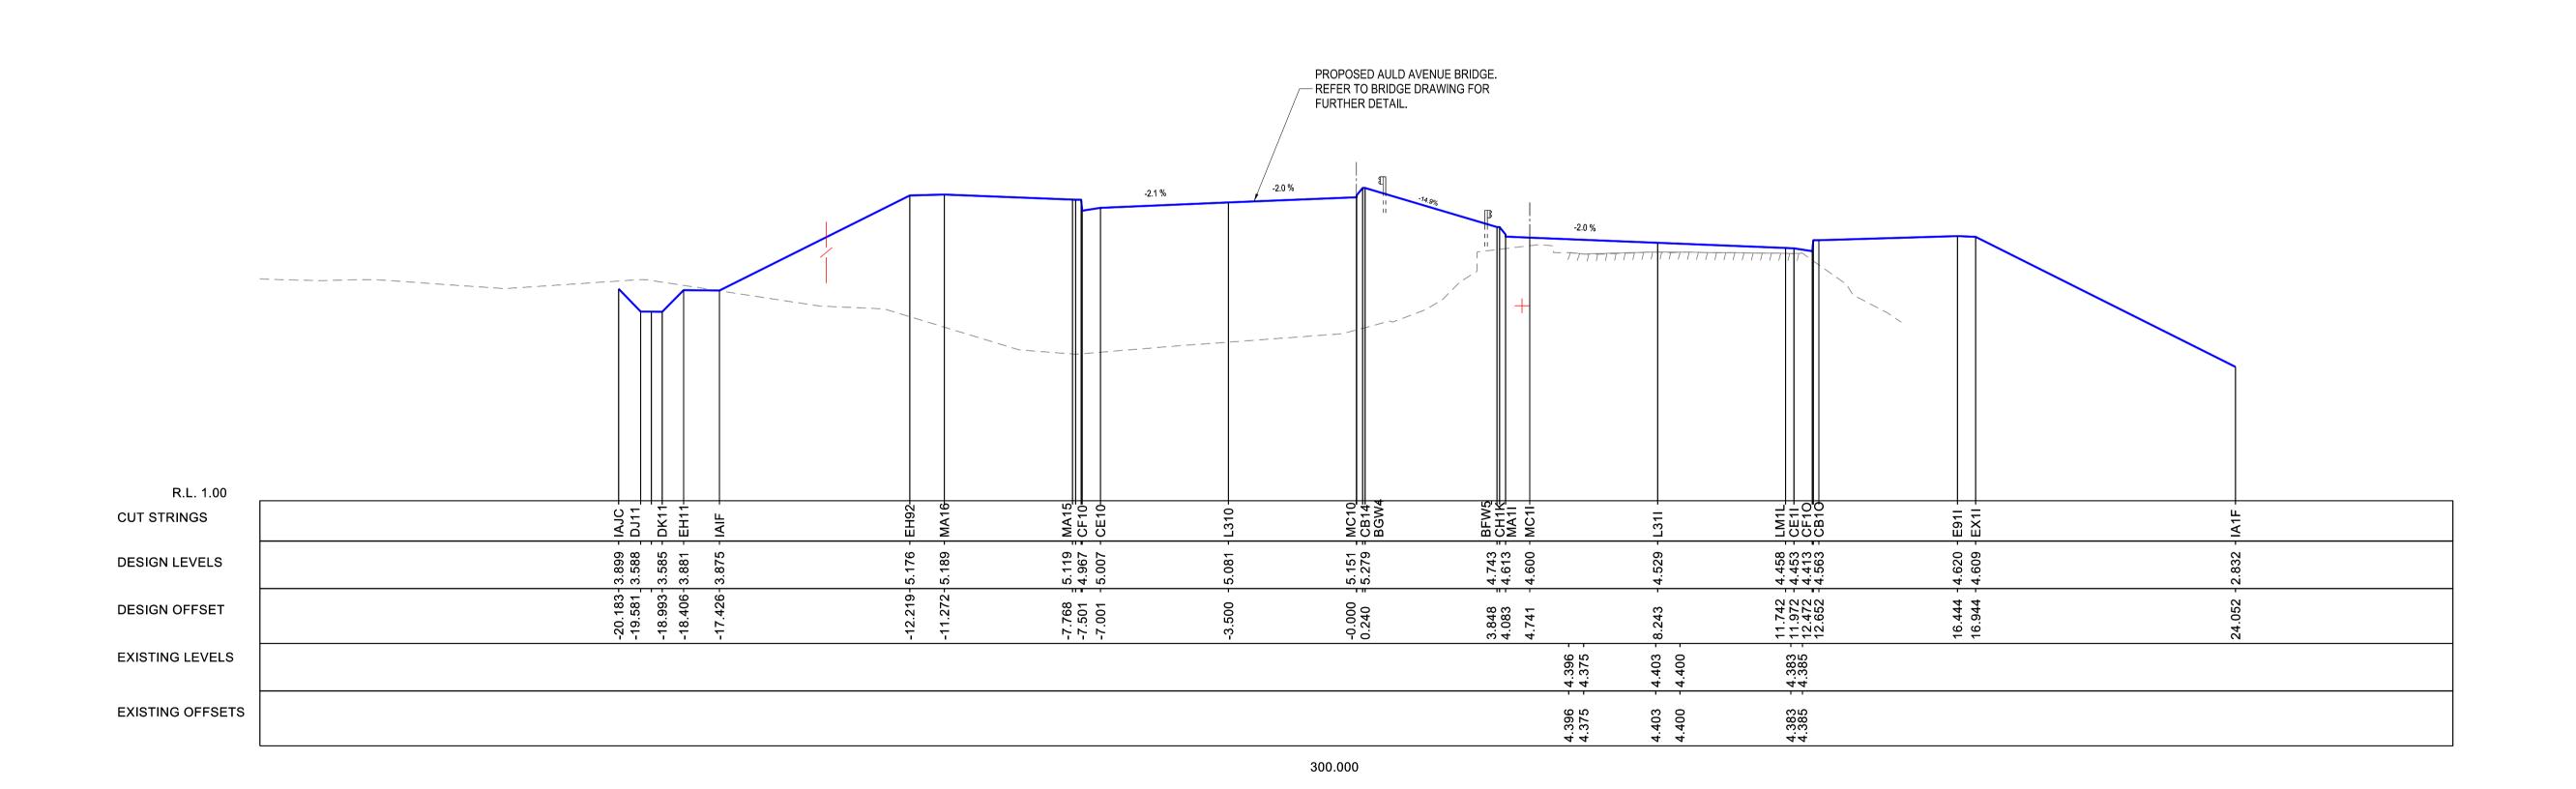

K:ICADDIDesign|pds14|Henry Lawson Drive and Milpera Road|Drawings|CAD||Sheets||80%||DS2019-001427-RC-0004.dgn EXTERNAL REFERENCE FILES REV DATE AMENDMENT / REVISION REV DATE AMENDMENT / REVISION DESCRIPTION 01 04-05-2020 ISSUED FOR 20% DESIGN 02 29-05-2020 ISSUED FOR 50% DESIGN 02 31-08-2020 ISSUED FOR 80% DESIGN

DESIGN LOT CODE DESIGN MODEL FILE(S) USED FOR DOCUMENTATION OF THIS DRAWING CO-ORDINATE SYSTEM HEIGHT DATUM ROAD DESIGN ENGINEERING TECHNOLOGY ROAD DESIGN ENGINEERING

PLOT DATE / TIME 4/09/2020 3:46:07 PM PLOT BY ngukinh TITLE NAME DATE
DATE
DRAWN VINCENT NGUYEN 29.05.20
DRG CHECK BEN CARTWRIGHT 29.05.20
DESIGN MNGR TIM HUFTON 29.05.20
PROJECT MNGR SARAH ABID 29.05.20
PROJECT MNGR SARAH ABID 29.05.20



NOT FOR CONSTRUCTION CANTERBURY - BANKSTOWN CITY COUNCIL
MR508 HENRY LAWSON DRIVE
HENRY LAWSON DRIVE BETWEEN TOWER ROAD AND AULD AVENUE
CROSS SECTIONS - HENRY LAWSON DRIVE MC10
MC10 - CHAINAGE 300.00 TO CHAINAGE 320.00

RMS REGISTRATION No. DS2019 / 001427

ISSUE STATUS
80% CONCEPT - REFERENCE DESIGN SF2019/233157 RC-0004 A

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LEGEND

———— DESIGN SURFACE

EXISTING PAVEMENT

— — — EXISTING SURFACE

FLOWER POWER W.A.E SURFACE

EXISTING FENCE

CADASTRAL BOUNDARIES


PROPOSED BARRIERS

HIGH PRESSURE GAS

TELEPHONE

WATER MAIN

OPTICAL FIBRE UNDERGROUND

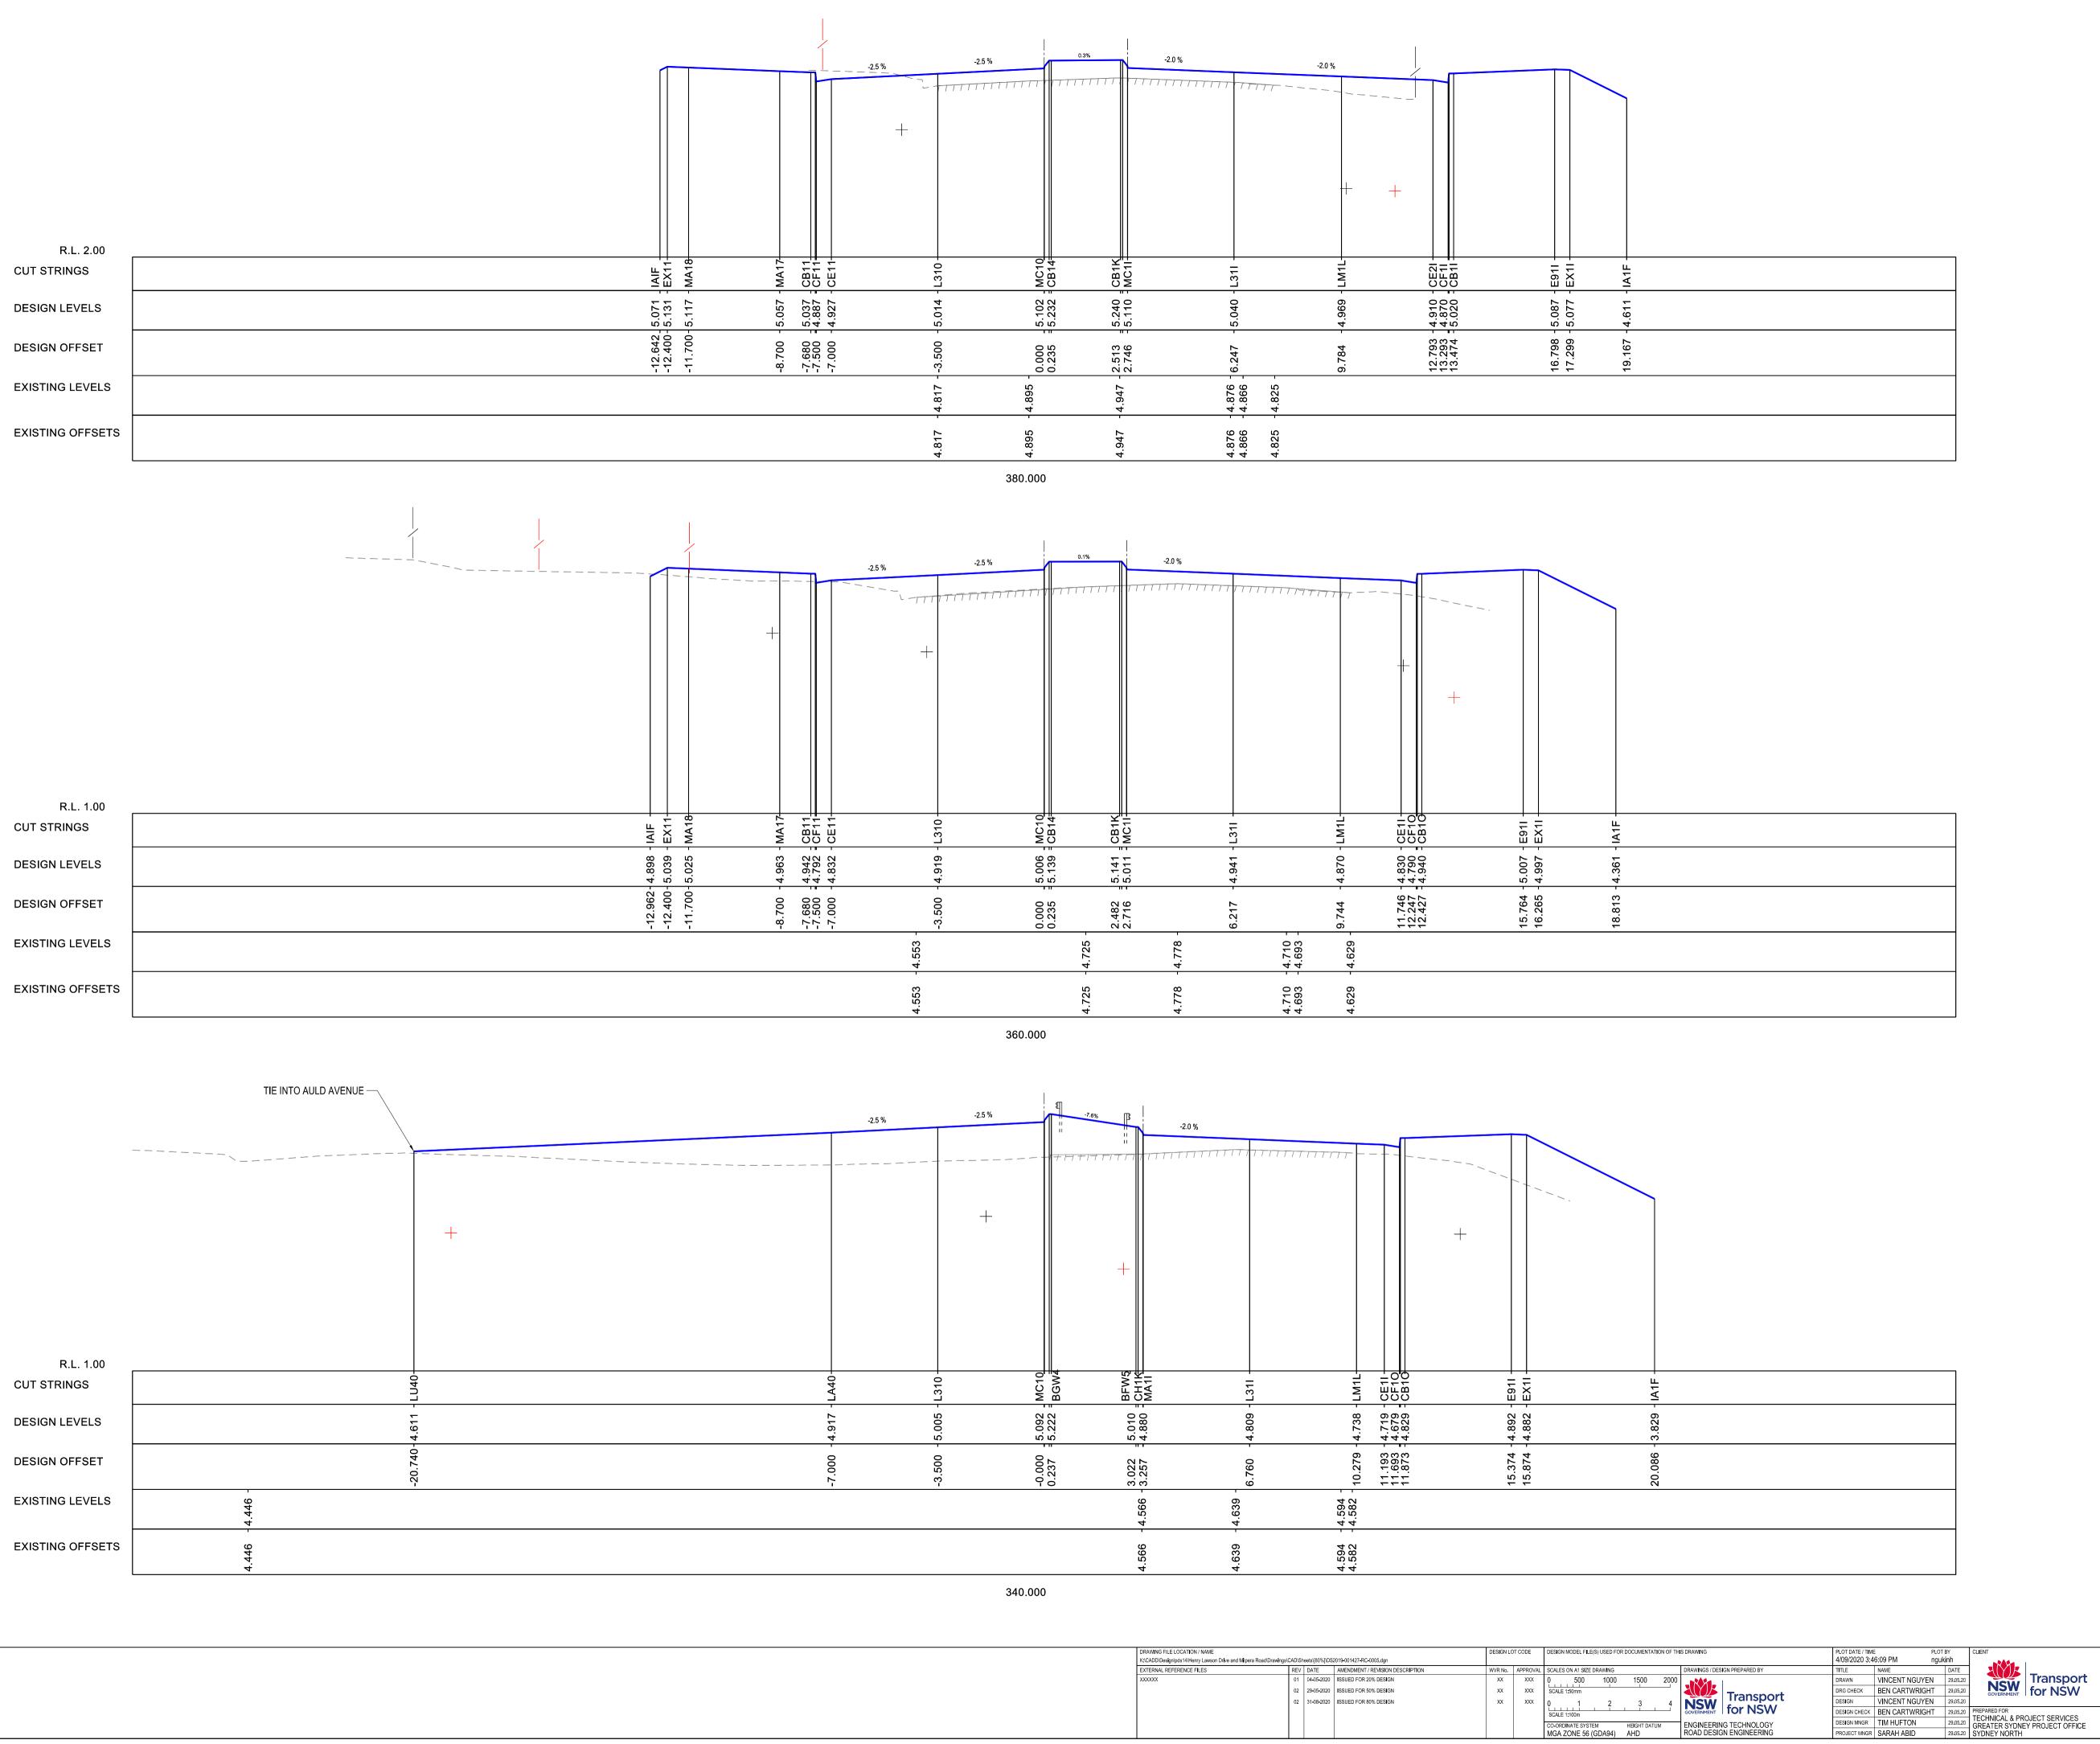

NOT FOR CONSTRUCTION CANTERBURY - BANKSTOWN CITY COUNCIL
MR508 HENRY LAWSON DRIVE
HENRY LAWSON DRIVE BETWEEN TOWER ROAD

Transport for NSW

CO-ORDINATE SYSTEM HEIGHT DATUM
MGA ZONE 56 (GDA94) AHD

LEGEND

———— DESIGN SURFACE

------ EXISTING PAVEMENT

— — — EXISTING SURFACE

FLOWER POWER W.A.E SURFACE

EXISTING FENCE

CADASTRAL BOUNDARIES

PROPOSED BARRIERS

HIGH PRESSURE GAS

TELEPHONE

WATER MAIN

OPTICAL FIBRE UNDERGROUND


ELECTRICAL UNDERGROUND


AND AULD AVENUE
CROSS SECTIONS - HENRY LAWSON DRIVE MC10
MC10 - CHAINAGE 340.00 TO CHAINAGE 380.00


RMS REGISTRATION No. DS2019 / 001427

ISSUE STATUS
80% CONCEPT - REFERENCE DESIGN SF2019/233157 RC-0005 A

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900.000
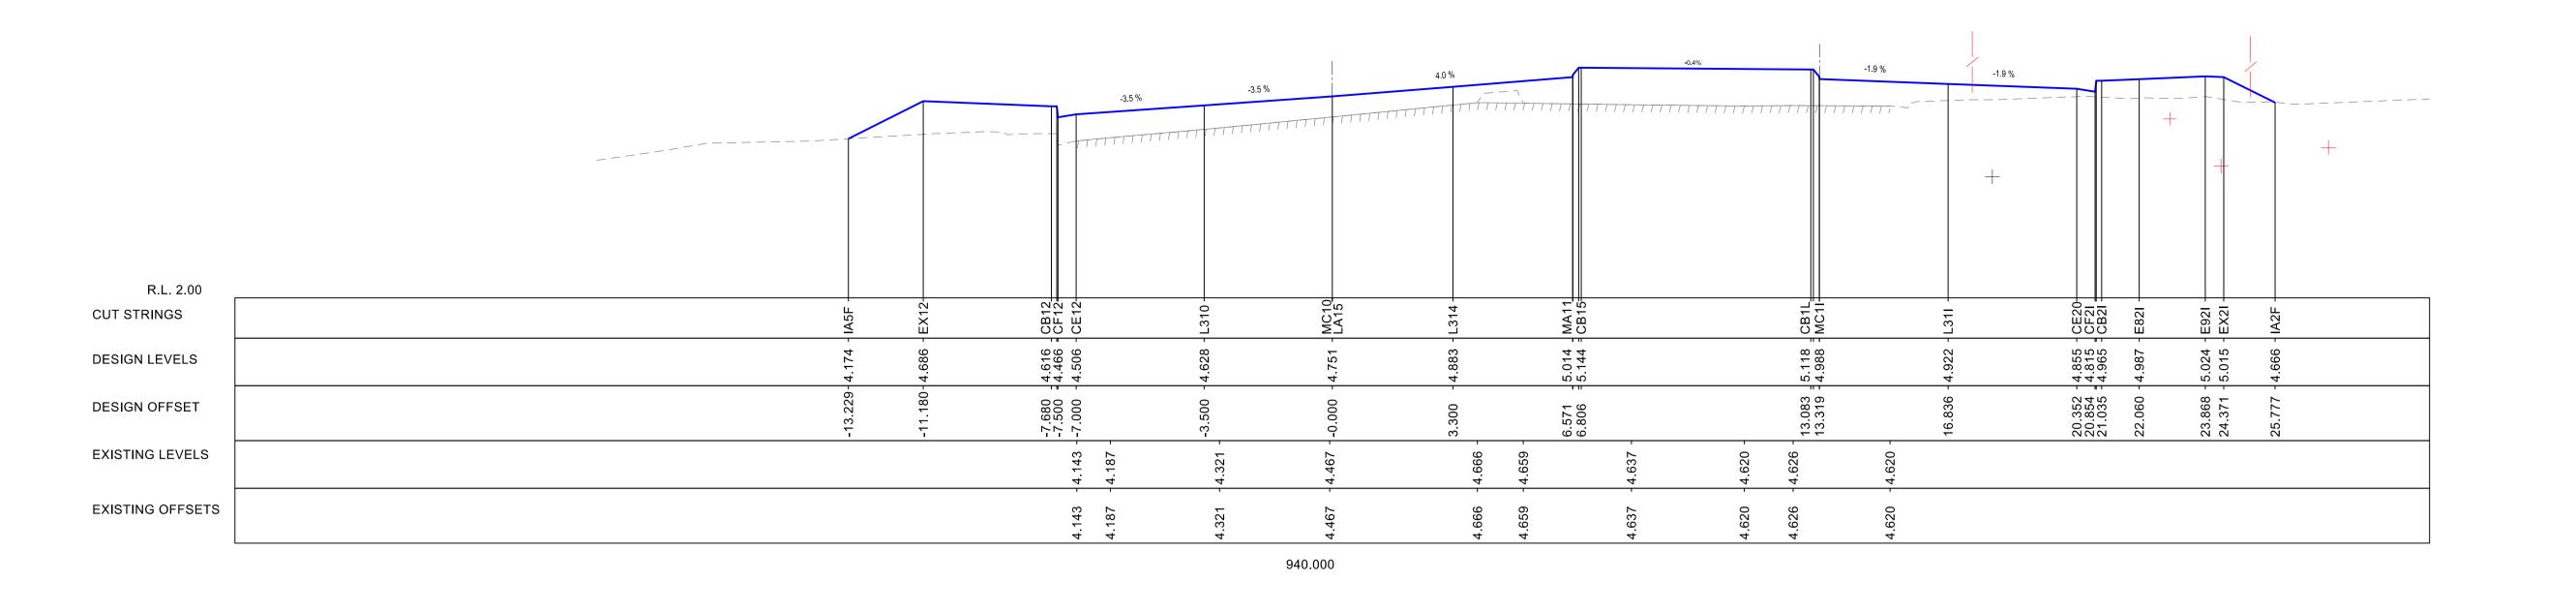
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PLOT BY ngukinh Transport for NSW DRAWN VINCENT NGUYEN 29.05.20
DRG CHECK BEN CARTWRIGHT 29.05.20
DESIGN VINCENT NGUYEN 29.05.20
DESIGN CHECK BEN CARTWRIGHT 29.05.20
DESIGN MNGR TIM HUFTON 29.05.20
PROJECT MNGR SARAH ABID 29.05.20
PROJECT MNGR SARAH ABID 29.05.20

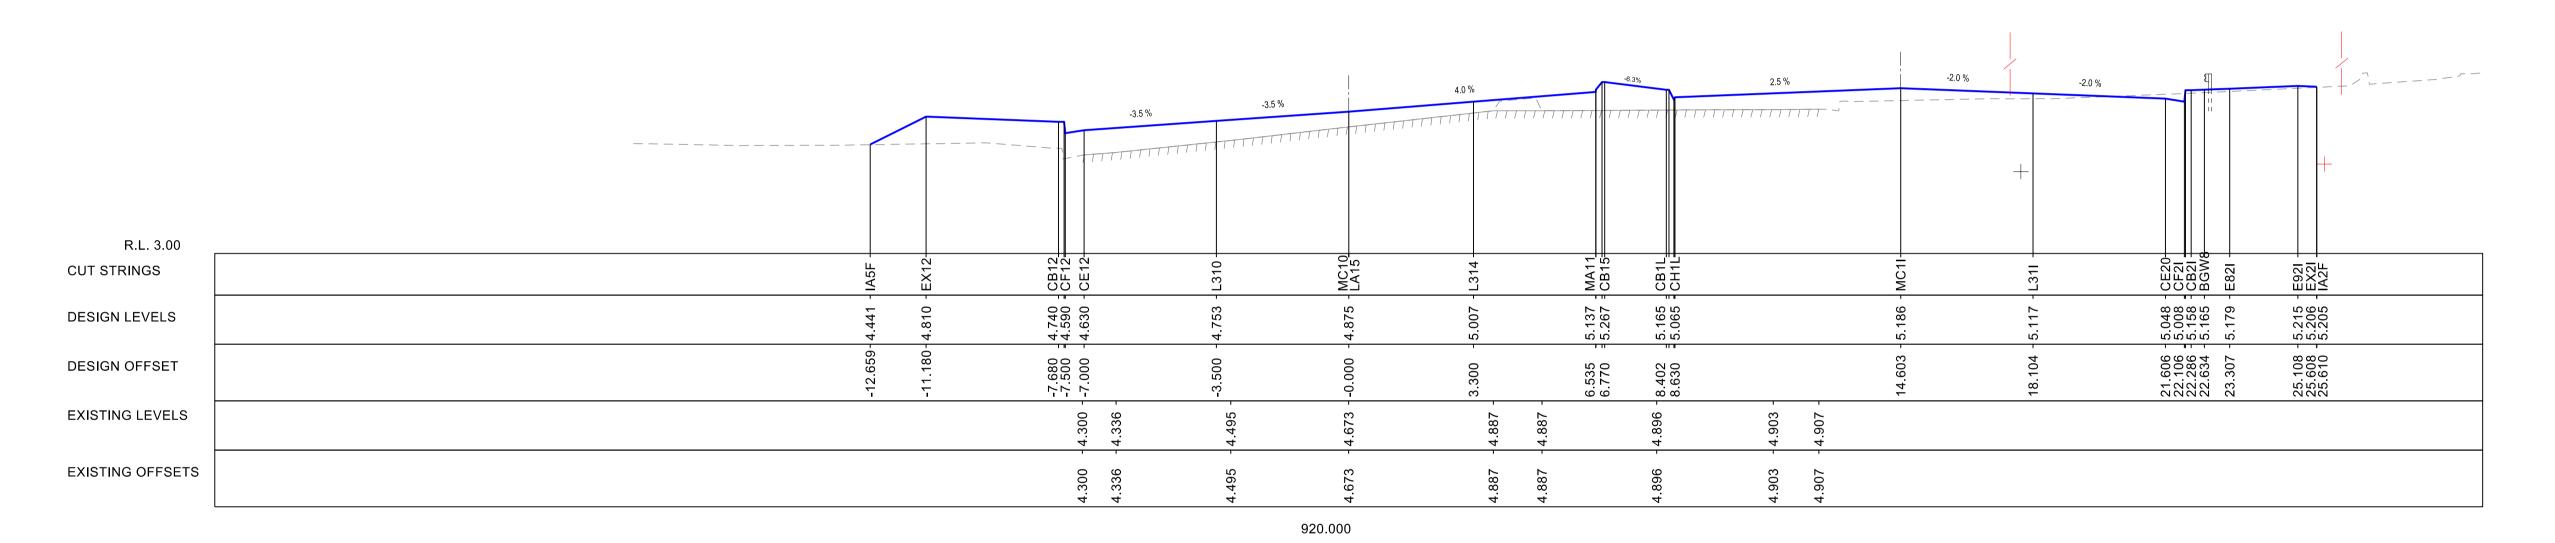PROJECT MNGR SARAH ABID 29.05.20

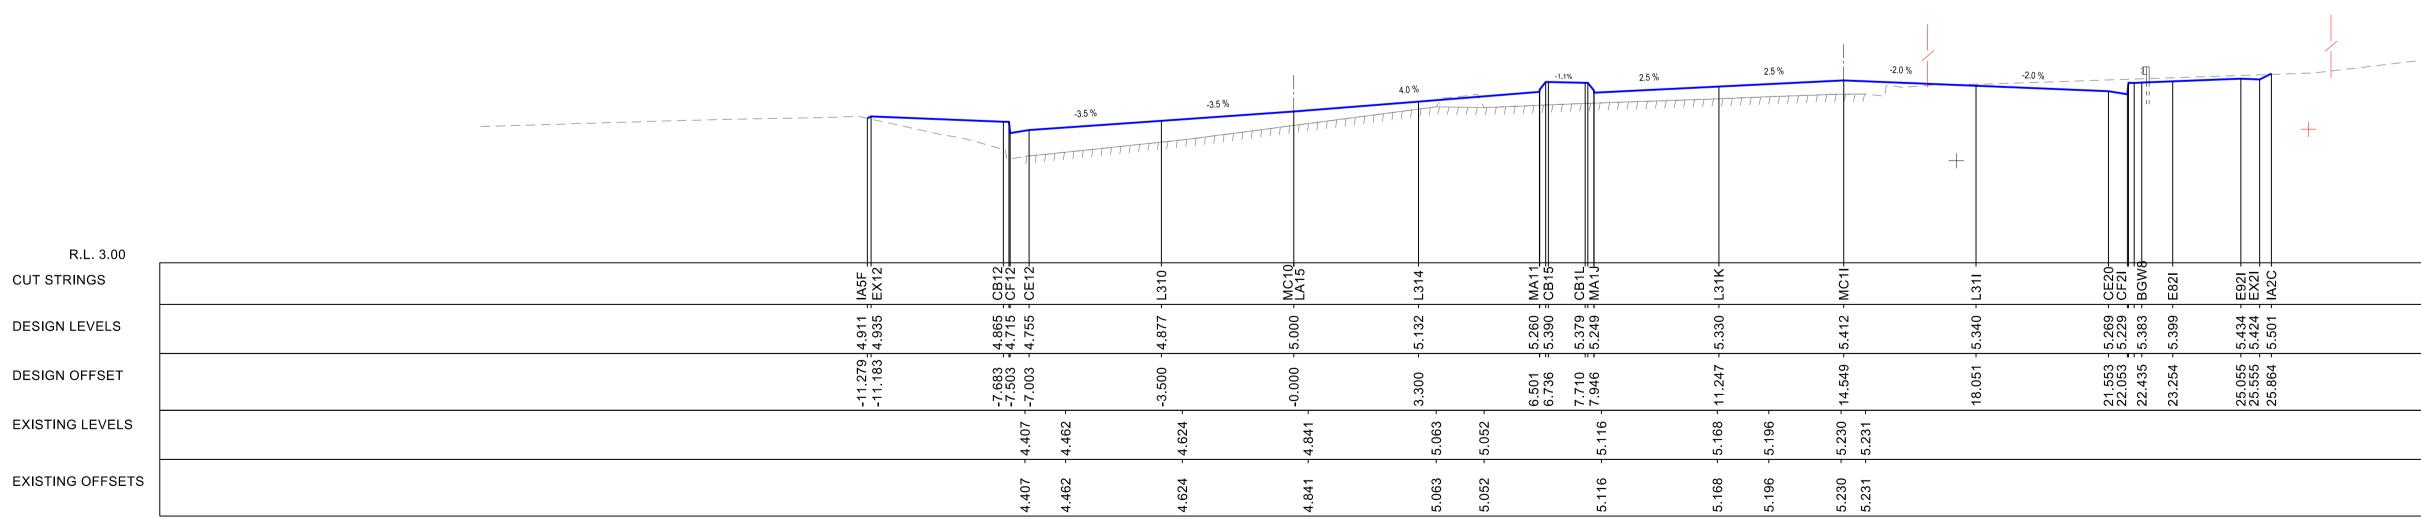PROJECT MNGR SARAH ABID 29.05.20

PROJECT MNGR SARAH ABID 29.05.20

PLOT DATE / TIME 4/09/2020 3:46:29 PM

NOT FOR CONSTRUCTION CANTERBURY - BANKSTOWN CITY COUNCIL
MR508 HENRY LAWSON DRIVE
HENRY LAWSON DRIVE BETWEEN TOWER ROAD AND AULD AVENUE
CROSS SECTIONS - HENRY LAWSON DRIVE MC10
MC10 - CHAINAGE 900.00 TO CHAINAGE 940.00

RMS REGISTRATION NO. DS2019 / 001427
ISSUE STATUS
80% CONCEPT - REFERENCE DESIGN SF2019/233157 RC-0015 A

© Transport for NSW

LEGEND

———— DESIGN SURFACE

EXISTING PAVEMENT

— — — EXISTING SURFACE

FLOWER POWER W.A.E SURFACE

EXISTING FENCE

CADASTRAL BOUNDARIES


PROPOSED BARRIERS

HIGH PRESSURE GAS

TELEPHONE

WATER MAIN

OPTICAL FIBRE UNDERGROUND

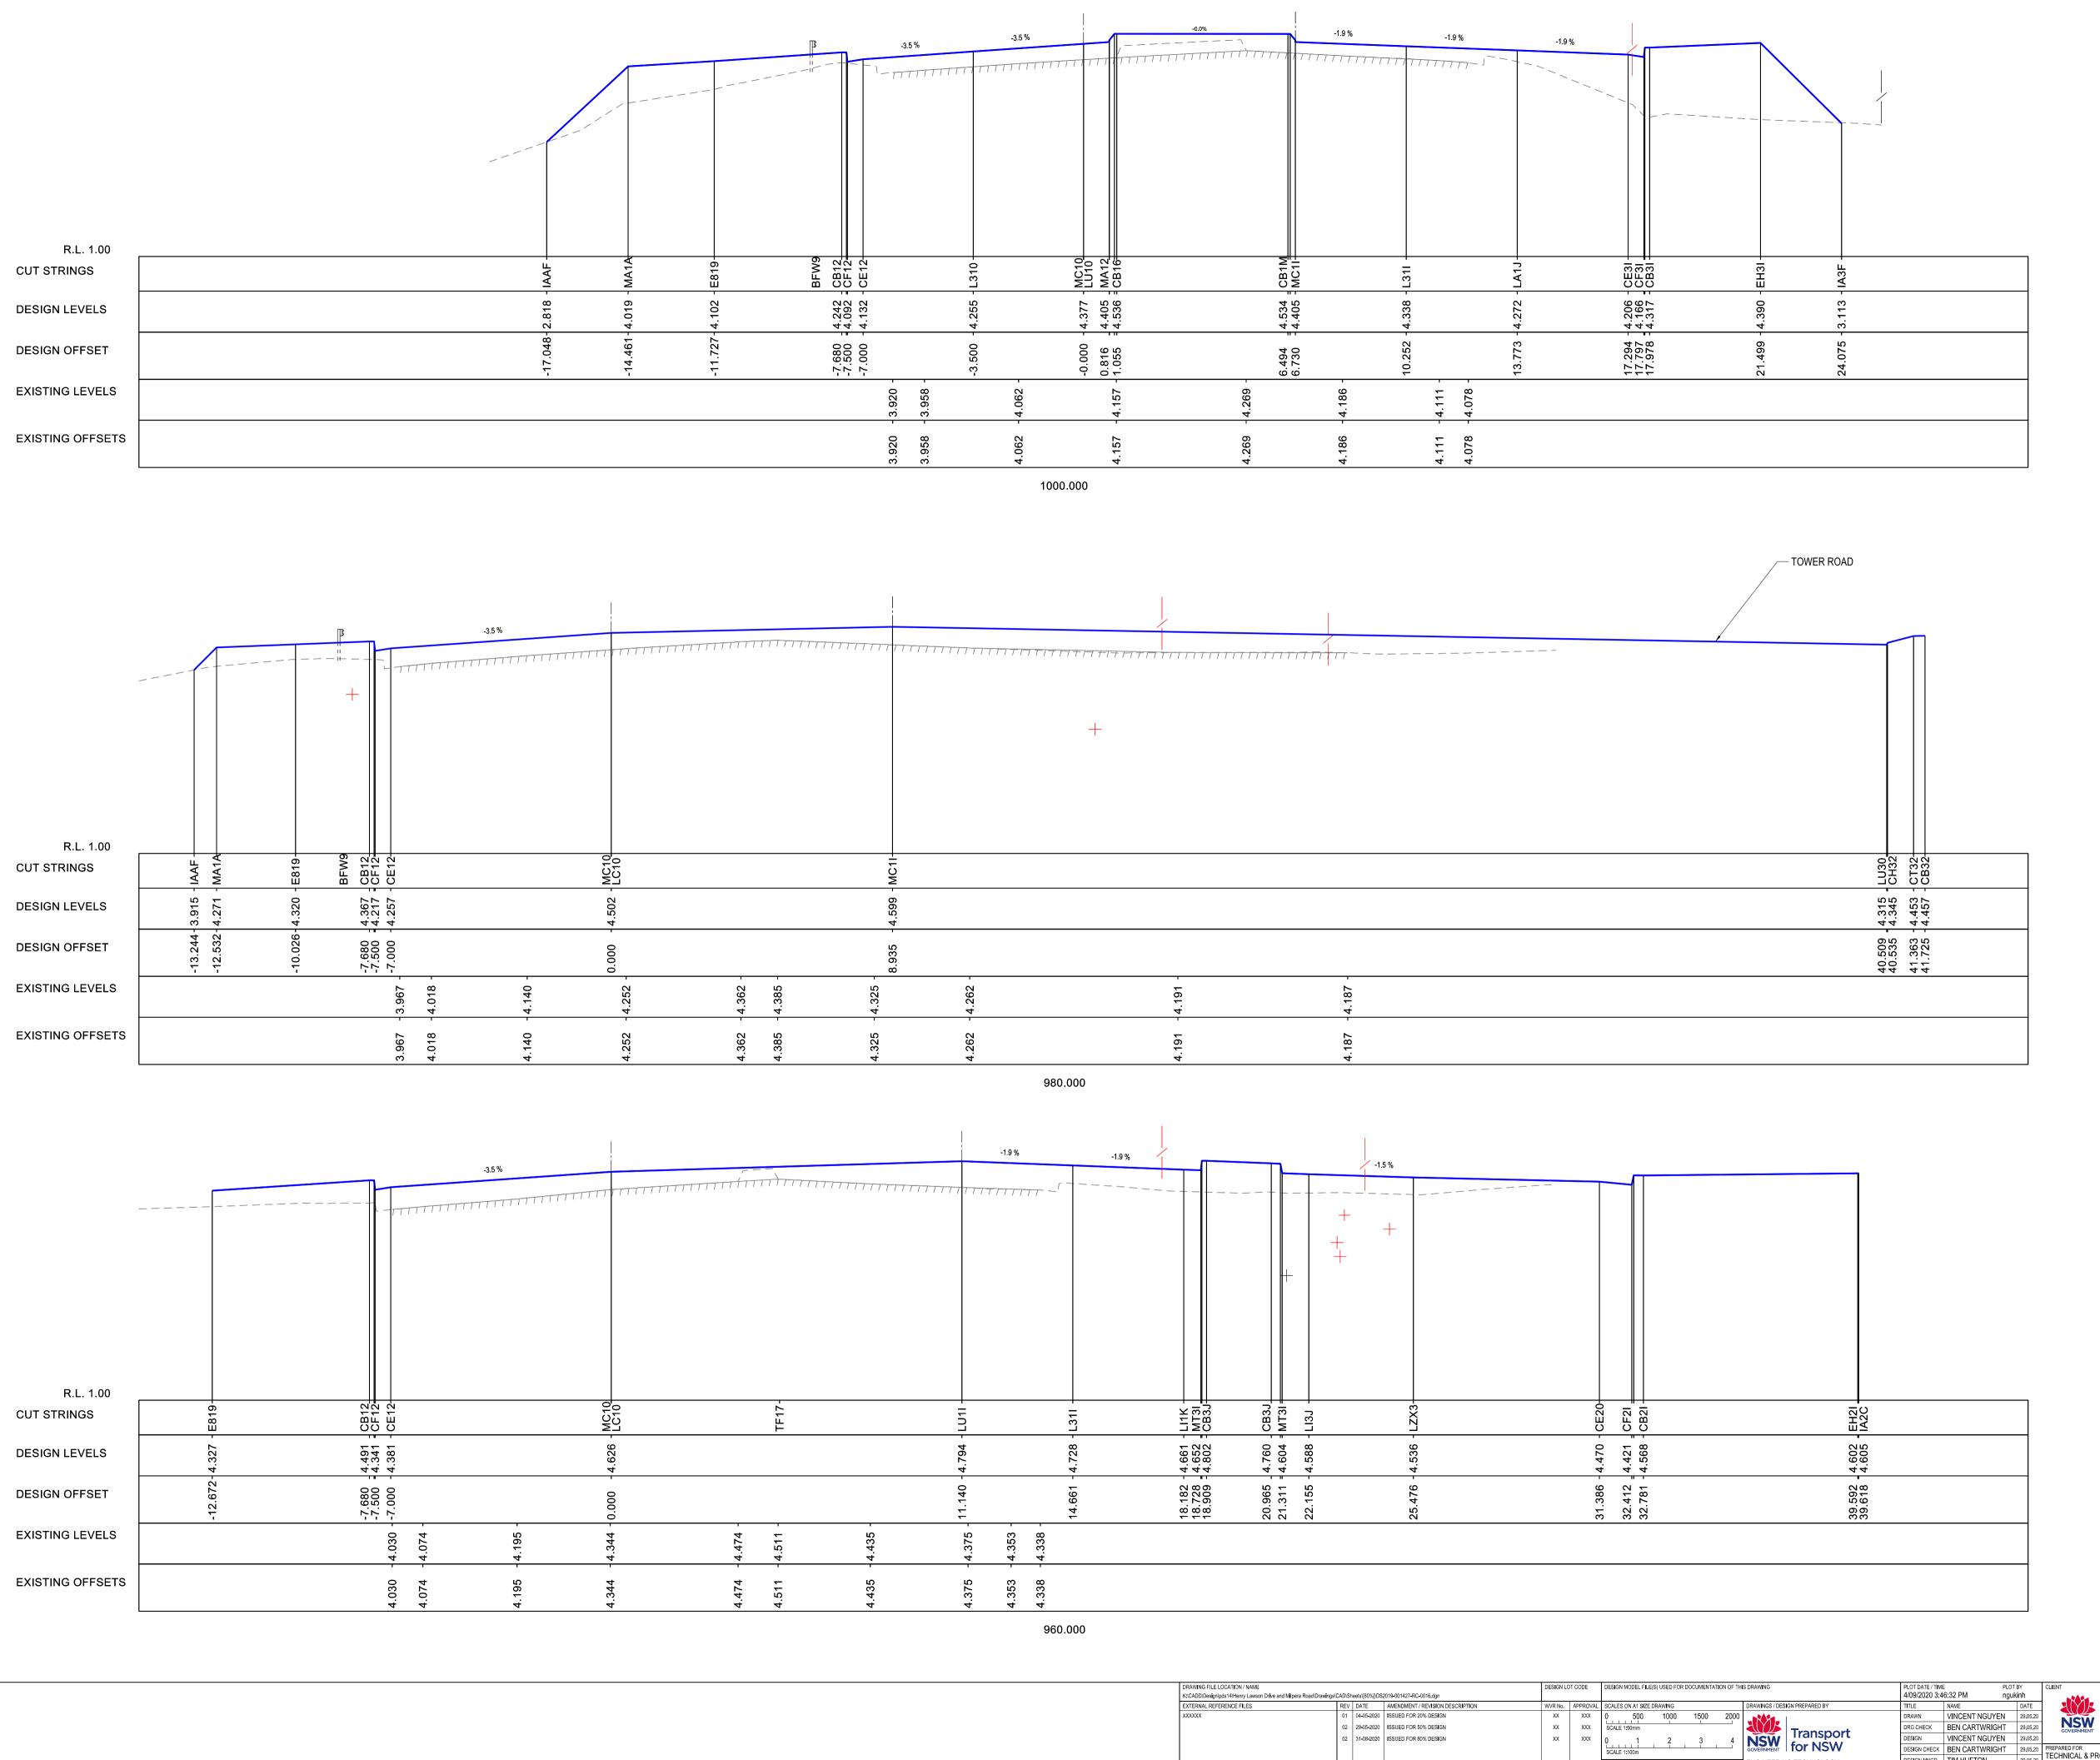

02 29-05-2020 ISSUED FOR 50% DESIGN

02 31-08-2020 ISSUED FOR 80% DESIGN

CO-ORDINATE SYSTEM HEIGHT DATUM
MGA ZONE 56 (GDA94) AHD

NOT FOR CONSTRUCTION CANTERBURY - BANKSTOWN CITY COUNCIL
MR508 HENRY LAWSON DRIVE
HENRY LAWSON DRIVE BETWEEN TOWER ROAD AND AULD AVENUE
CROSS SECTIONS - HENRY LAWSON DRIVE MC10
MC10 - CHAINAGE 960.00 TO CHAINAGE 1000.00

LEGEND

———— DESIGN SURFACE

EXISTING PAVEMENT

— — — EXISTING SURFACE

FLOWER POWER W.A.E SURFACE

EXISTING FENCE

CADASTRAL BOUNDARIES

PROPOSED BARRIERS

HIGH PRESSURE GAS

TELEPHONE

WATER MAIN

OPTICAL FIBRE UNDERGROUND

ELECTRICAL UNDERGROUND

TITLE NAME DATE

DRAWN VINCENT NGUYEN 29.05.20

DRG CHECK BEN CARTWRIGHT 29.05.20

DESIGN VINCENT NGUYEN 29.05.20


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DESIGN MNGR TIM HUFTON 29.05.20

PROJECT MNGR SARAH ABID 29.05.20

SYDNEY NORTH Transport for NSW



02 31-08-2020 ISSUED FOR 80% DESIGN

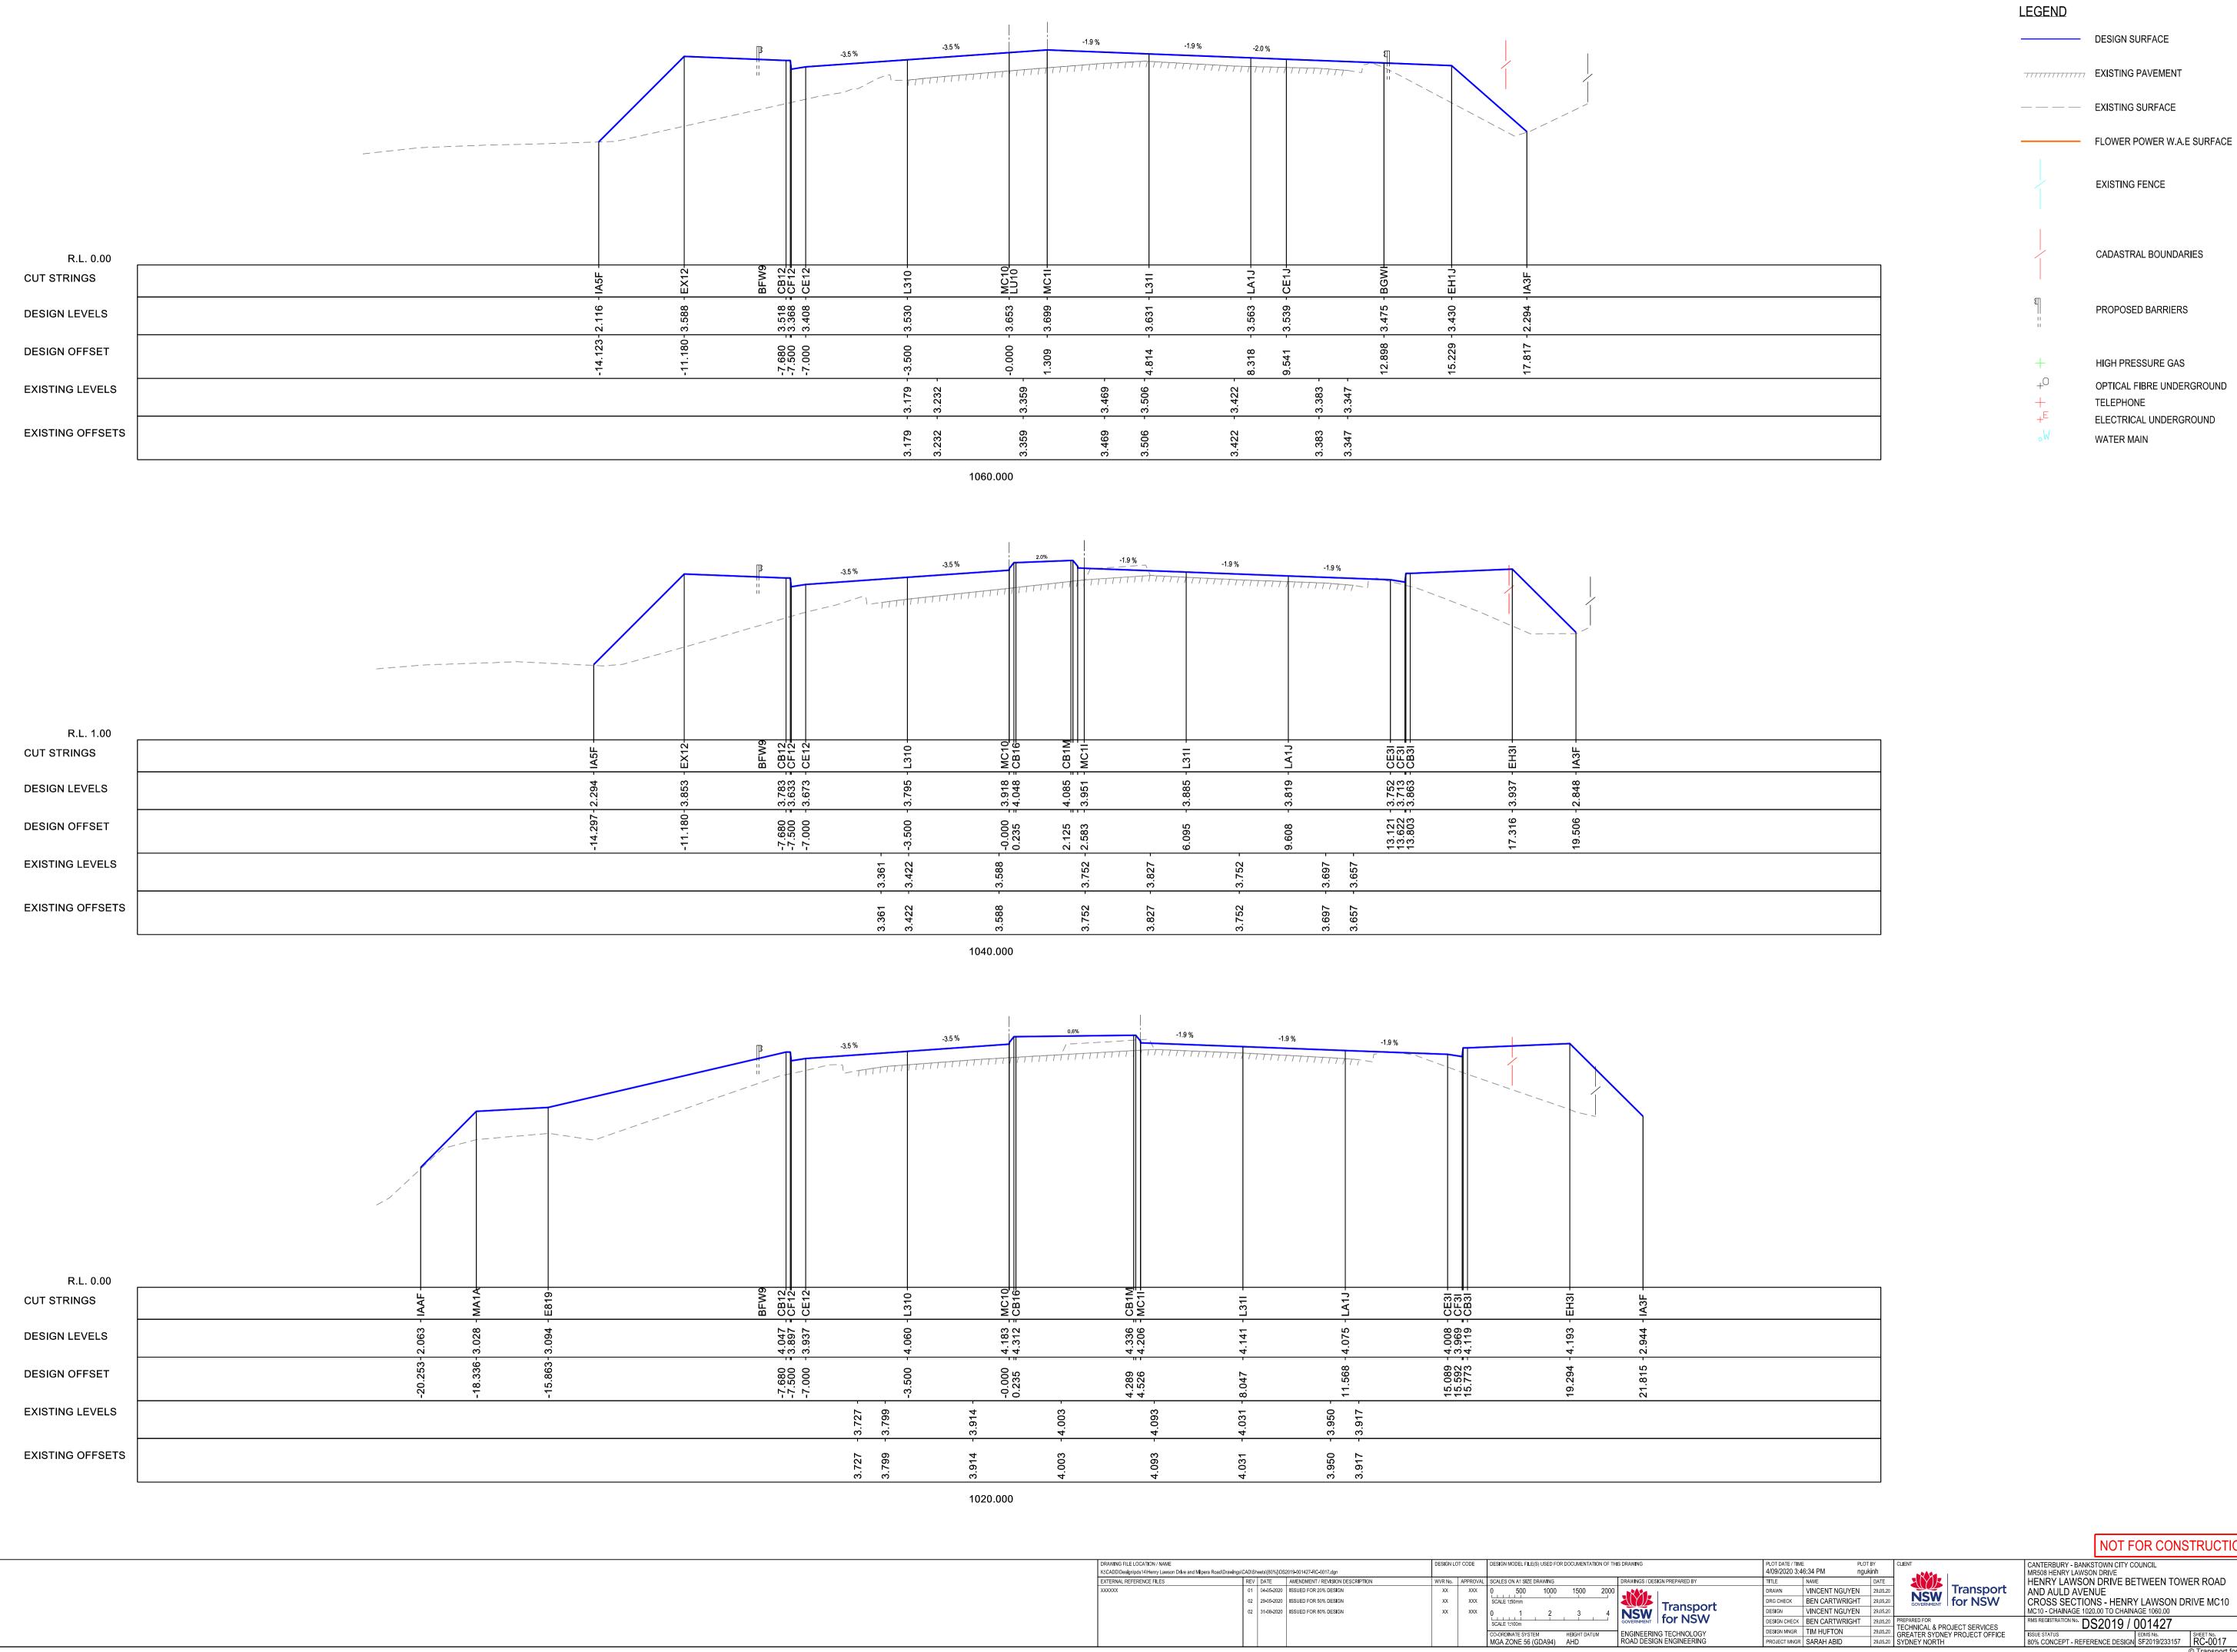CO-ORDINATE SYSTEM HEIGHT DATUM MGA ZONE 56 (GDA94) AHD

Transport for NSW

NOT FOR CONSTRUCTION CANTERBURY - BANKSTOWN CITY COUNCIL
MR508 HENRY LAWSON DRIVE
HENRY LAWSON DRIVE BETWEEN TOWER ROAD AND AULD AVENUE
CROSS SECTIONS - HENRY LAWSON DRIVE MC10
MC10 - CHAINAGE 1020.00 TO CHAINAGE 1060.00

EXISTING FENCE

CADASTRAL BOUNDARIES


PROPOSED BARRIERS

HIGH PRESSURE GAS

TELEPHONE

WATER MAIN

OPTICAL FIBRE UNDERGROUND

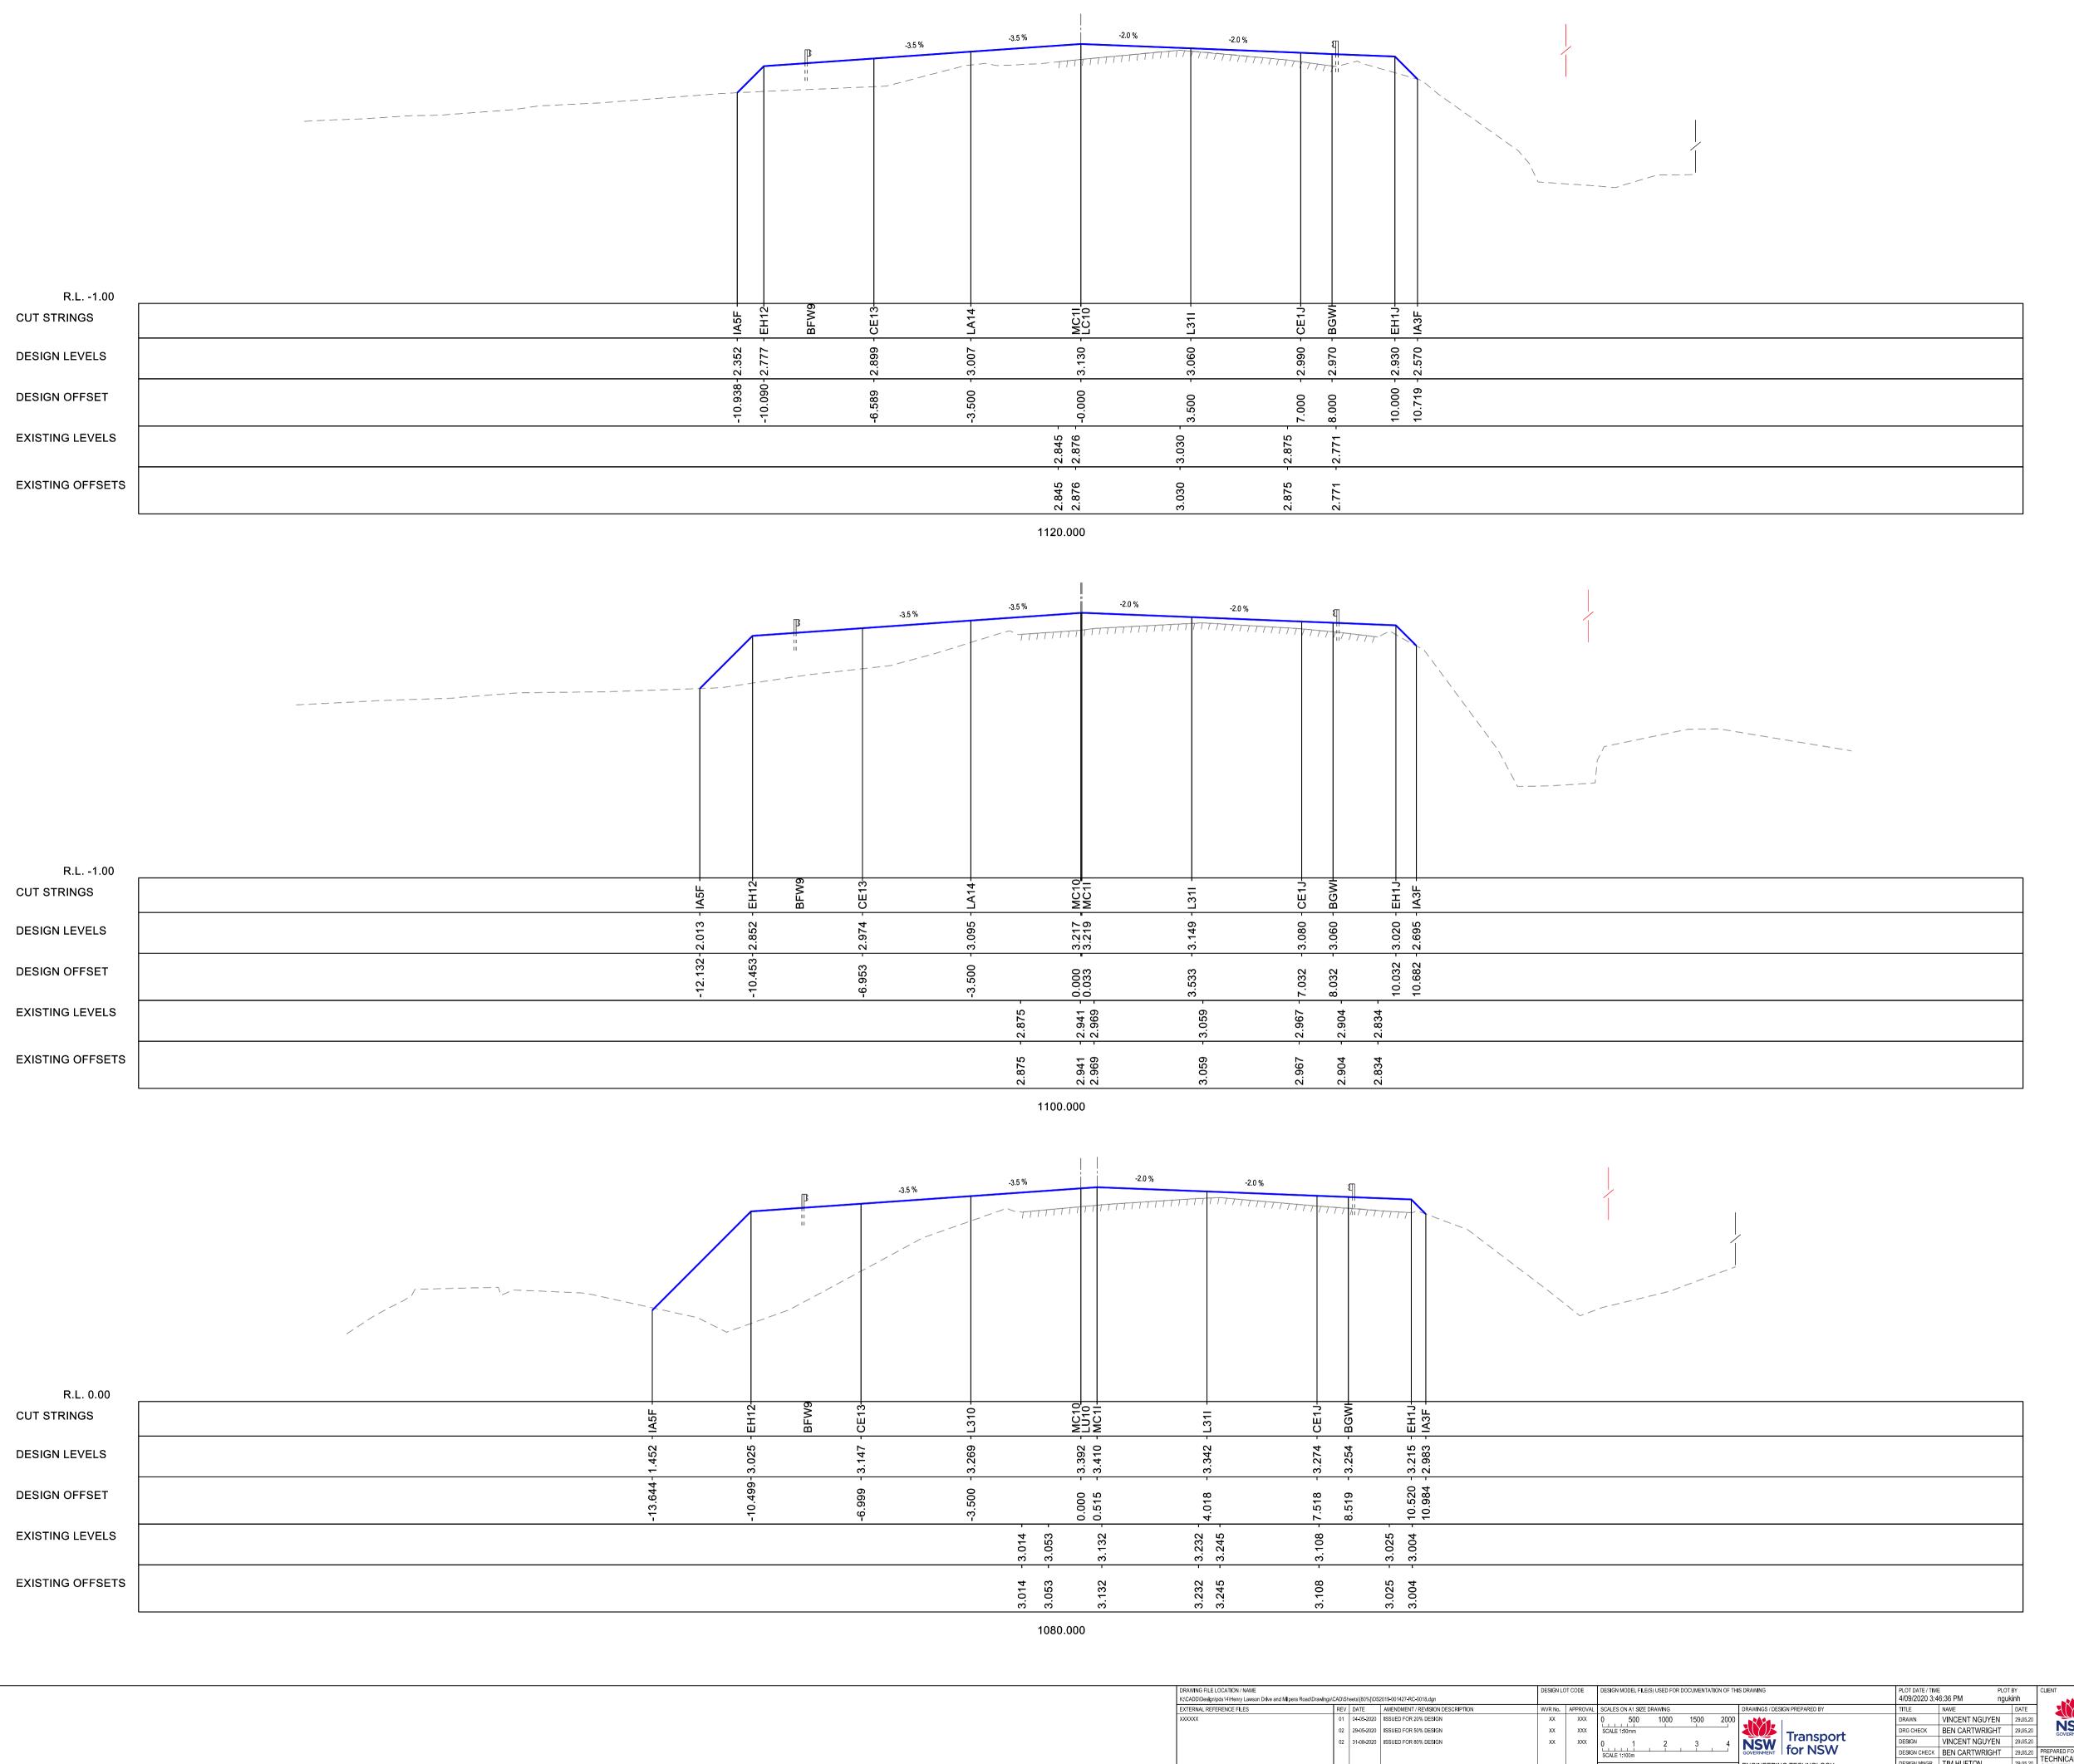

02 31-08-2020 ISSUED FOR 80% DESIGN

CO-ORDINATE SYSTEM HEIGHT DATUM
MGA ZONE 56 (GDA94) AHD

Transport for NSW TITLE NAME DATE
DATE
DRAWN VINCENT NGUYEN 29.05.20
DRG CHECK BEN CARTWRIGHT 29.05.20
DESIGN MNGR TIM HUFTON 29.05.20
PROJECT MNGR SARAH ABID 29.05.20
PROJECT MNGR SARAH ABID 29.05.20

LEGEND

———— DESIGN SURFACE

EXISTING PAVEMENT

— — — EXISTING SURFACE

FLOWER POWER W.A.E SURFACE

CADASTRAL BOUNDARIES

PROPOSED BARRIERS

HIGH PRESSURE GAS

TELEPHONE

WATER MAIN

OPTICAL FIBRE UNDERGROUND


ELECTRICAL UNDERGROUND

EXISTING FENCE

NOT FOR CONSTRUCTION CANTERBURY - BANKSTOWN CITY COUNCIL
MR508 HENRY LAWSON DRIVE
HENRY LAWSON DRIVE BETWEEN TOWER ROAD
AND AULD AVENUE
CROSS SECTIONS - HENRY LAWSON DRIVE MC10
MC10 - CHAINAGE 1080.00 TO CHAINAGE 1120.00

RMS REGISTRATION NO.
DS2019 / 001427

ISSUE STATUS
80% CONCEPT - REFERENCE DESIGN | SF2019/233157 | SHEET NO. RC-0018 | A © Transport for NSW

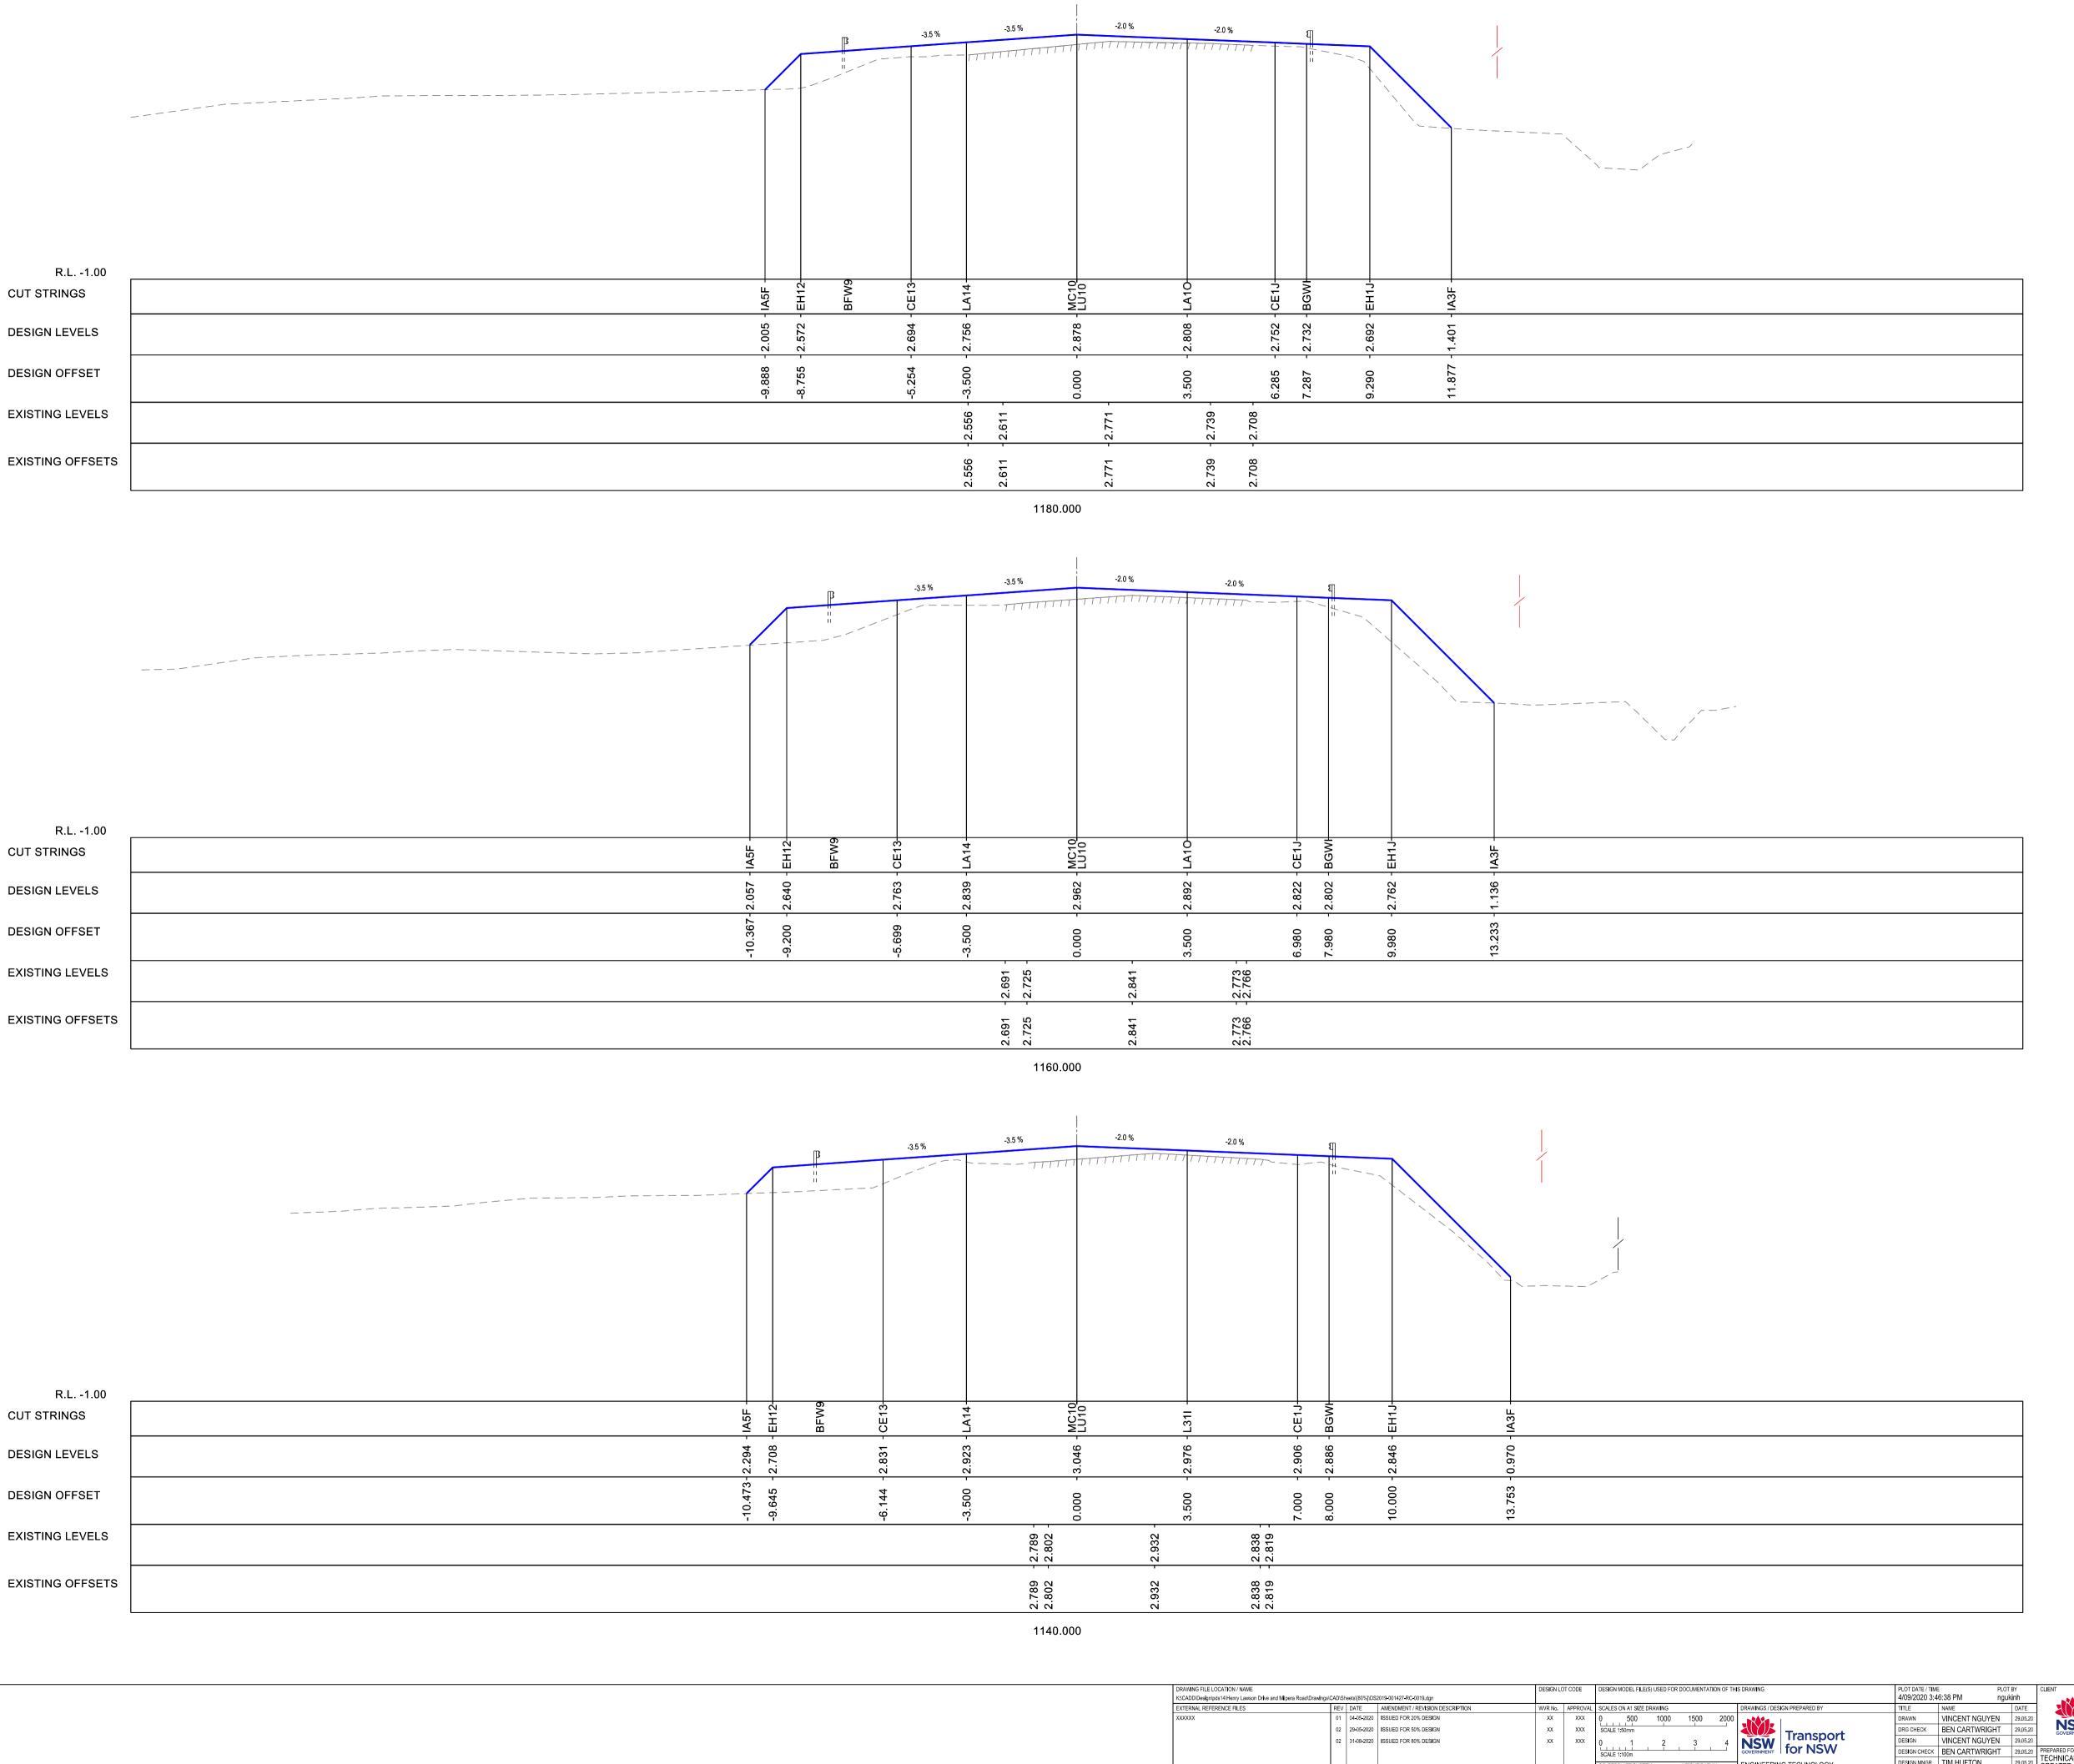

02 29-05-2020 ISSUED FOR 50% DESIGN 02 31-08-2020 ISSUED FOR 80% DESIGN

CO-ORDINATE SYSTEM HEIGHT DATUM
MGA ZONE 56 (GDA94) AHD

NOT FOR CONSTRUCTION CANTERBURY - BANKSTOWN CITY COUNCIL
MR508 HENRY LAWSON DRIVE
HENRY LAWSON DRIVE BETWEEN TOWER ROAD
AND AULD AVENUE
CROSS SECTIONS - HENRY LAWSON DRIVE MC10
MC10 - CHAINAGE 1140.00 TO CHAINAGE 1180.00

RMS REGISTRATION NO.
DS2019 / 001427

ISSUE STATUS
80% CONCEPT - REFERENCE DESIGN | SF2019/233157 | SHEET NO. | ISSUE
RC-0019 | A Transport for NSW TITLE NAME DATE
DATE
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DRG CHECK BEN CARTWRIGHT 29.05.20
DESIGN MNGR TIM HUFTON 29.05.20
PROJECT MNGR SARAH ABID 29.05.20
SYDNEY NORTH

LEGEND

———— DESIGN SURFACE

EXISTING PAVEMENT

— — — EXISTING SURFACE

FLOWER POWER W.A.E SURFACE

CADASTRAL BOUNDARIES

PROPOSED BARRIERS

HIGH PRESSURE GAS


TELEPHONE

WATER MAIN

OPTICAL FIBRE UNDERGROUND

ELECTRICAL UNDERGROUND

EXISTING FENCE

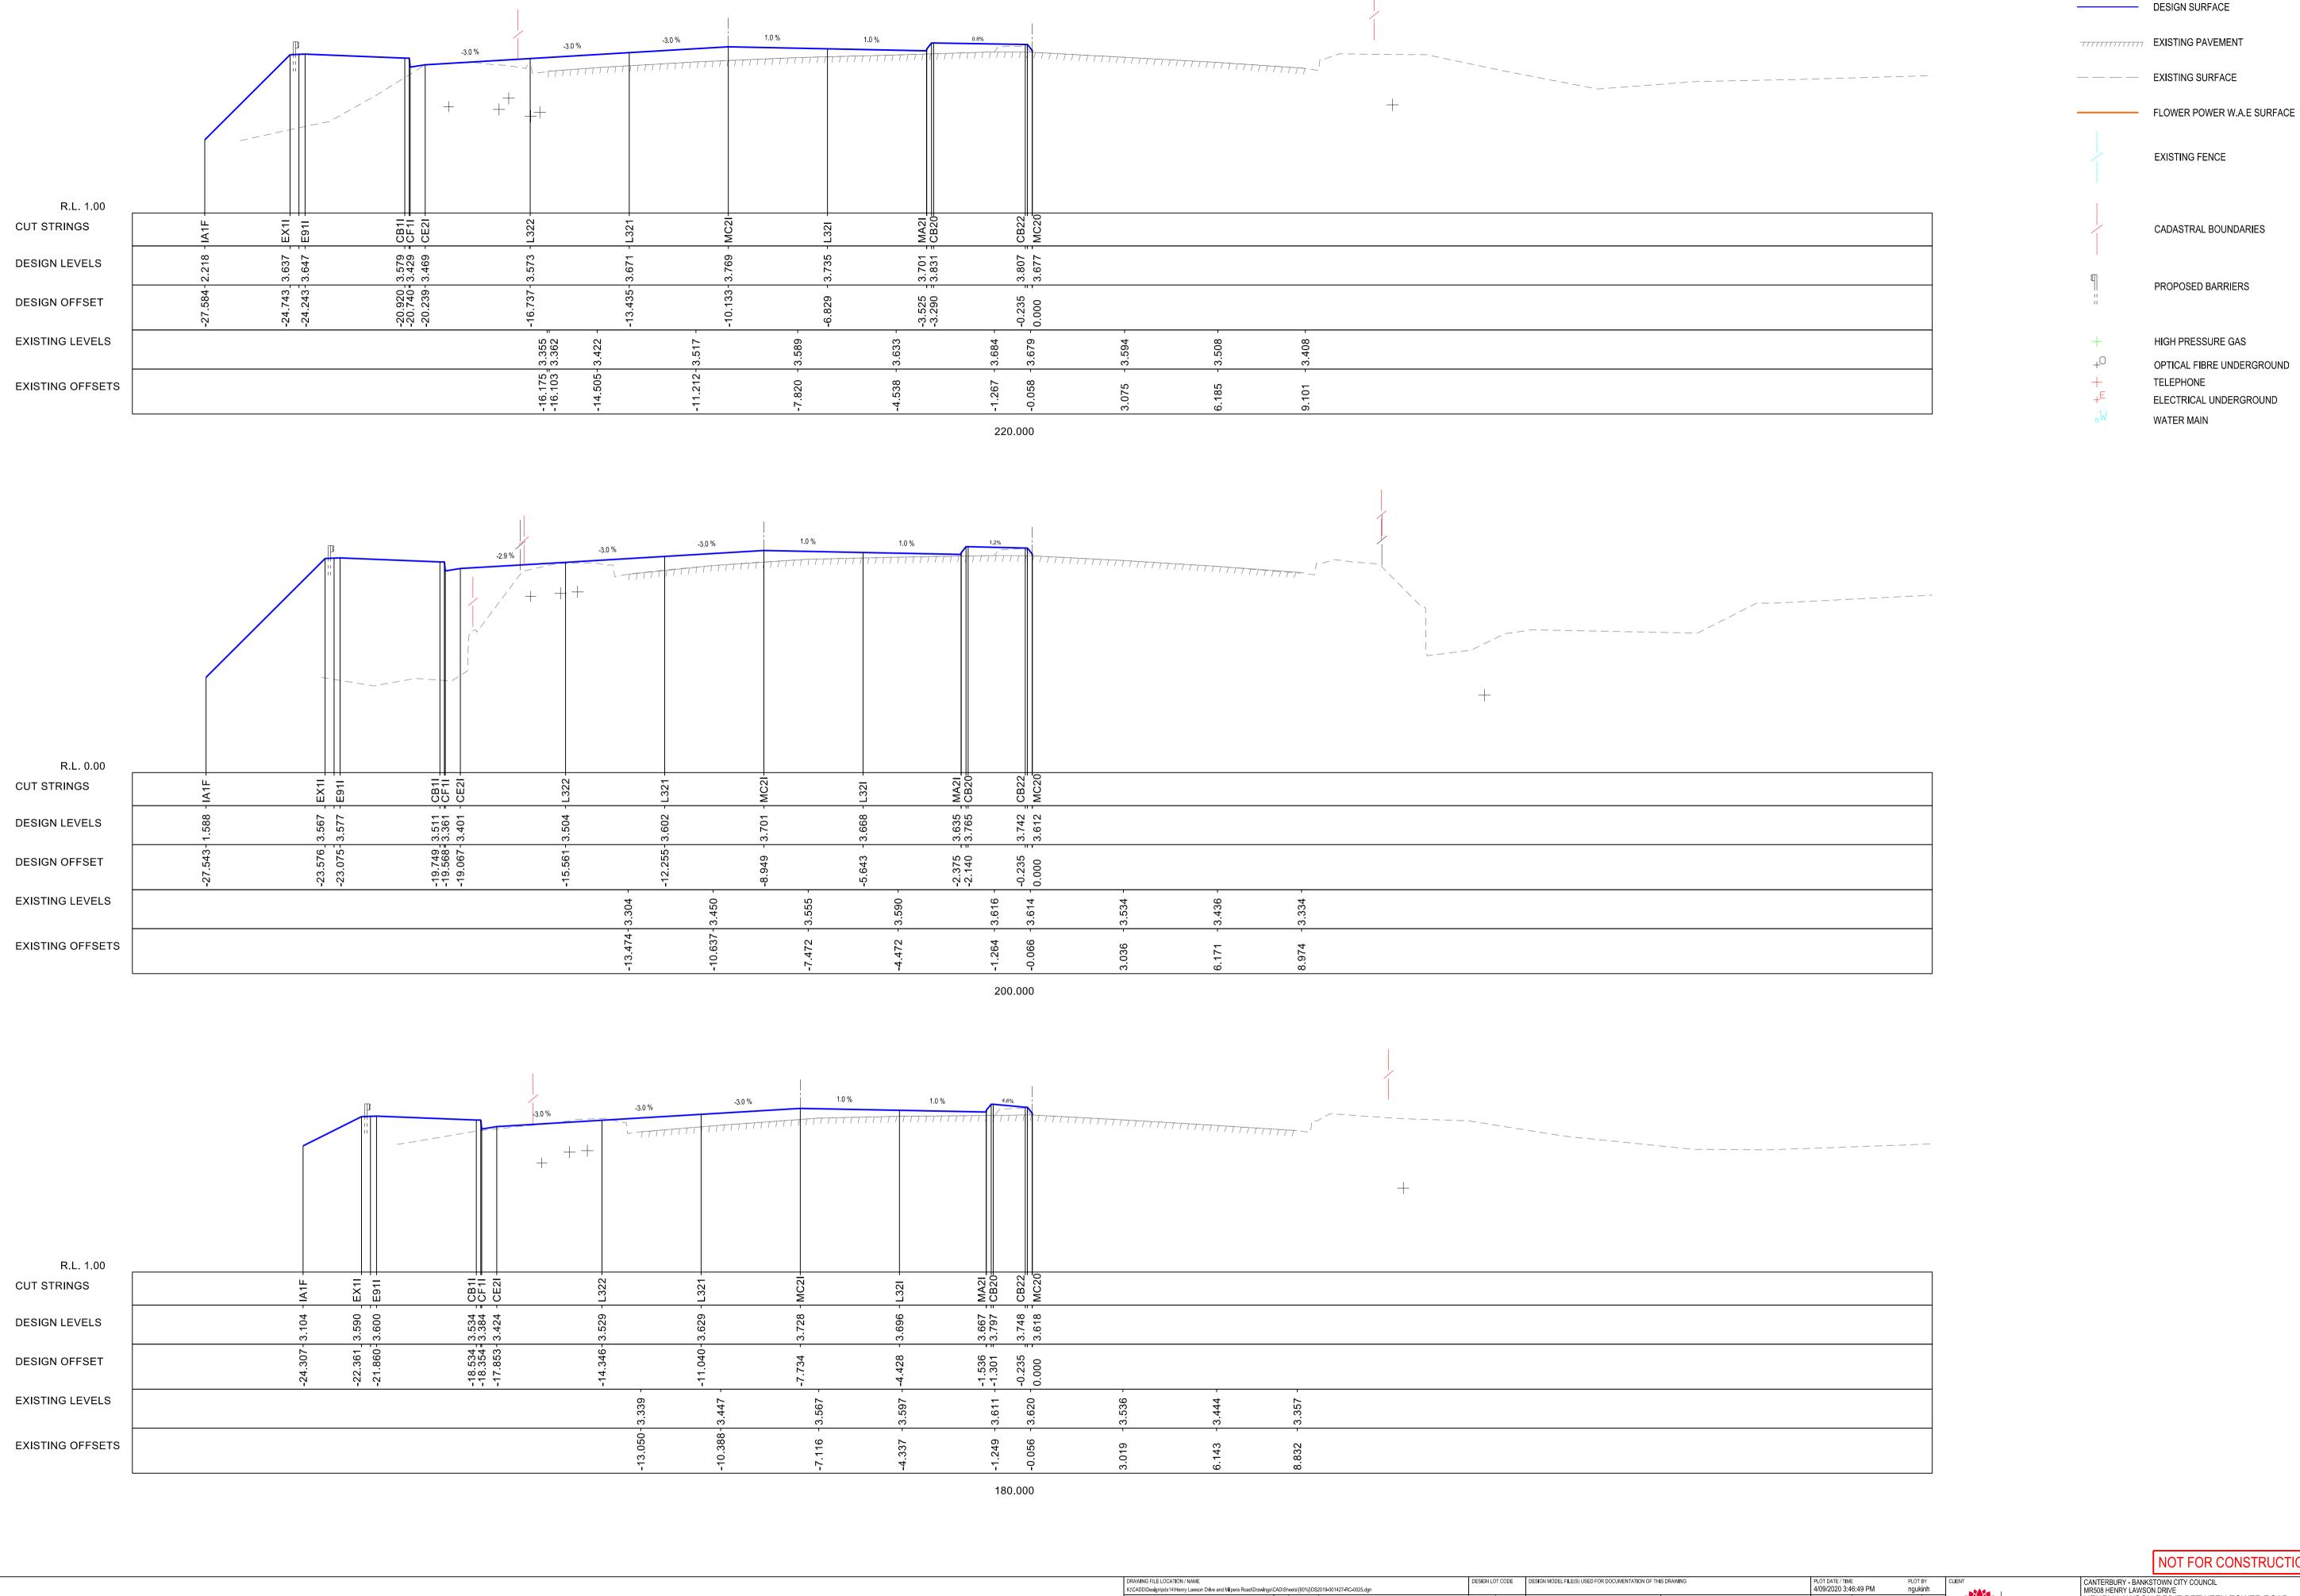

K:CADD\Design\pds14\Henry Lawson Drive and Milpera Road\Drawings\CAD\Shee EXTERNAL REFERENCE FILES REV [

REV DATE AMENDMENT / REVISION DESCRIPTION

01 04-05-2020 ISSUED FOR 20% DESIGN 02 29-05-2020 ISSUED FOR 50% DESIGN 02 31-08-2020 ISSUED FOR 80% DESIGN CO-ORDINATE SYSTEM HEIGHT DATUM
MGA ZONE 56 (GDA94) AHD

Transport for NSW

LEGEND

NOT FOR CONSTRUCTION CANTERBURY - BANKSTOWN CITY COUNCIL
MR508 HENRY LAWSON DRIVE
HENRY LAWSON DRIVE BETWEEN TOWER ROAD TITLE NAME DATE

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DRG CHECK BEN CARTWRIGHT 29.05.20

DESIGN VINCENT NGUYEN 29.05.20


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DESIGN CHECK BEN CARTWRIGHT 29.05.20

DESIGN MNGR TIM HUFTON 29.05.20

PROJECT MNGR SARAH ABID 29.05.20

SYDNEY NORTH AND AULD AVENUE
CROSS SECTIONS - MILPERRA ROAD MC20
OPTION 2A - REDUCE IMPACT TO EASTERN SIDE - 2 LANES NORTHBOUND

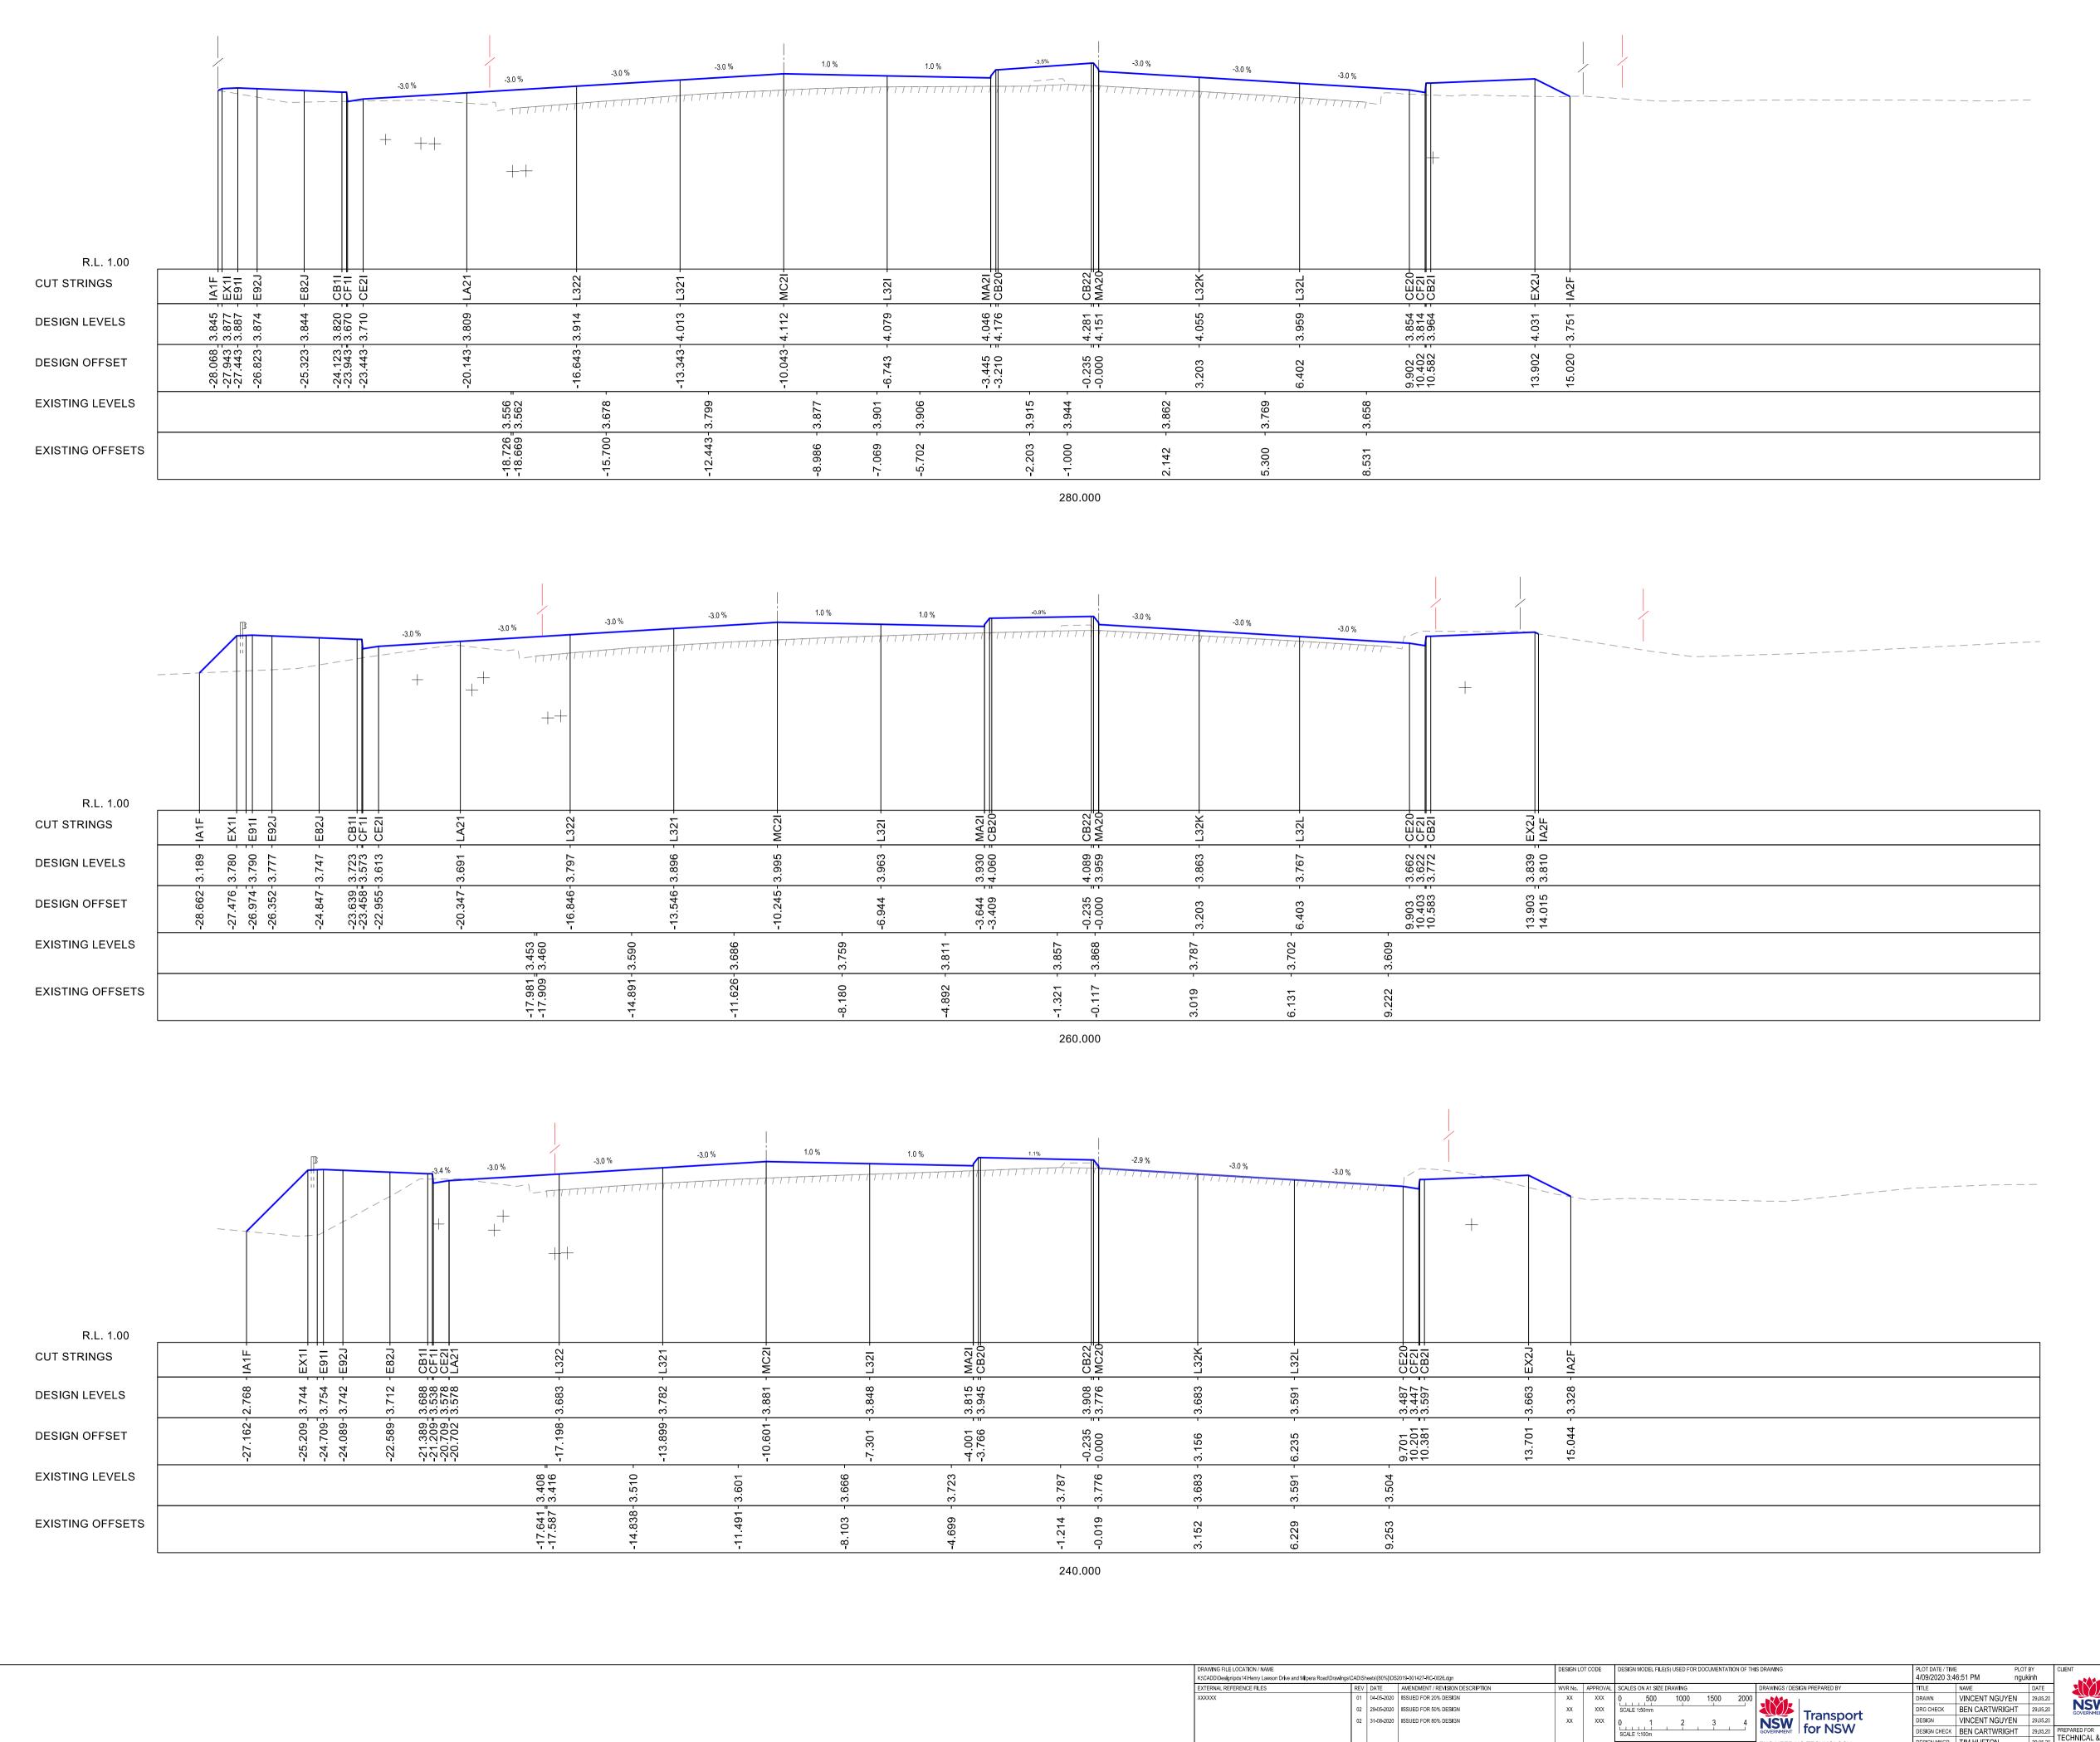

02 29-05-2020 ISSUED FOR 50% DESIGN

02 31-08-2020 ISSUED FOR 80% DESIGN

CO-ORDINATE SYSTEM HEIGHT DATUM MGA ZONE 56 (GDA94) AHD

LEGEND ———— DESIGN SURFACE EXISTING PAVEMENT — — — EXISTING SURFACE FLOWER POWER W.A.E SURFACE EXISTING FENCE CADASTRAL BOUNDARIES PROPOSED BARRIERS HIGH PRESSURE GAS OPTICAL FIBRE UNDERGROUND TELEPHONE ELECTRICAL UNDERGROUND WATER MAIN

NOT FOR CONSTRUCTION CANTERBURY - BANKSTOWN CITY COUNCIL
MR508 HENRY LAWSON DRIVE
HENRY LAWSON DRIVE BETWEEN TOWER ROAD

Transport for NSW TITLE NAME DATE

DRAWN VINCENT NGUYEN 29.05.20

DRG CHECK BEN CARTWRIGHT 29.05.20

DESIGN VINCENT NGUYEN 29.05.20


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DESIGN CHECK BEN CARTWRIGHT 29.05.20

DESIGN MNGR TIM HUFTON 29.05.20

PROJECT MNGR SARAH ABID 29.05.20

SYDNEY NORTH AND AULD AVENUE
CROSS SECTIONS - MILPERRA ROAD MC20
OPTION 2A - REDUCE IMPACT TO EASTERN SIDE - 2 LANES NORTHBOUND

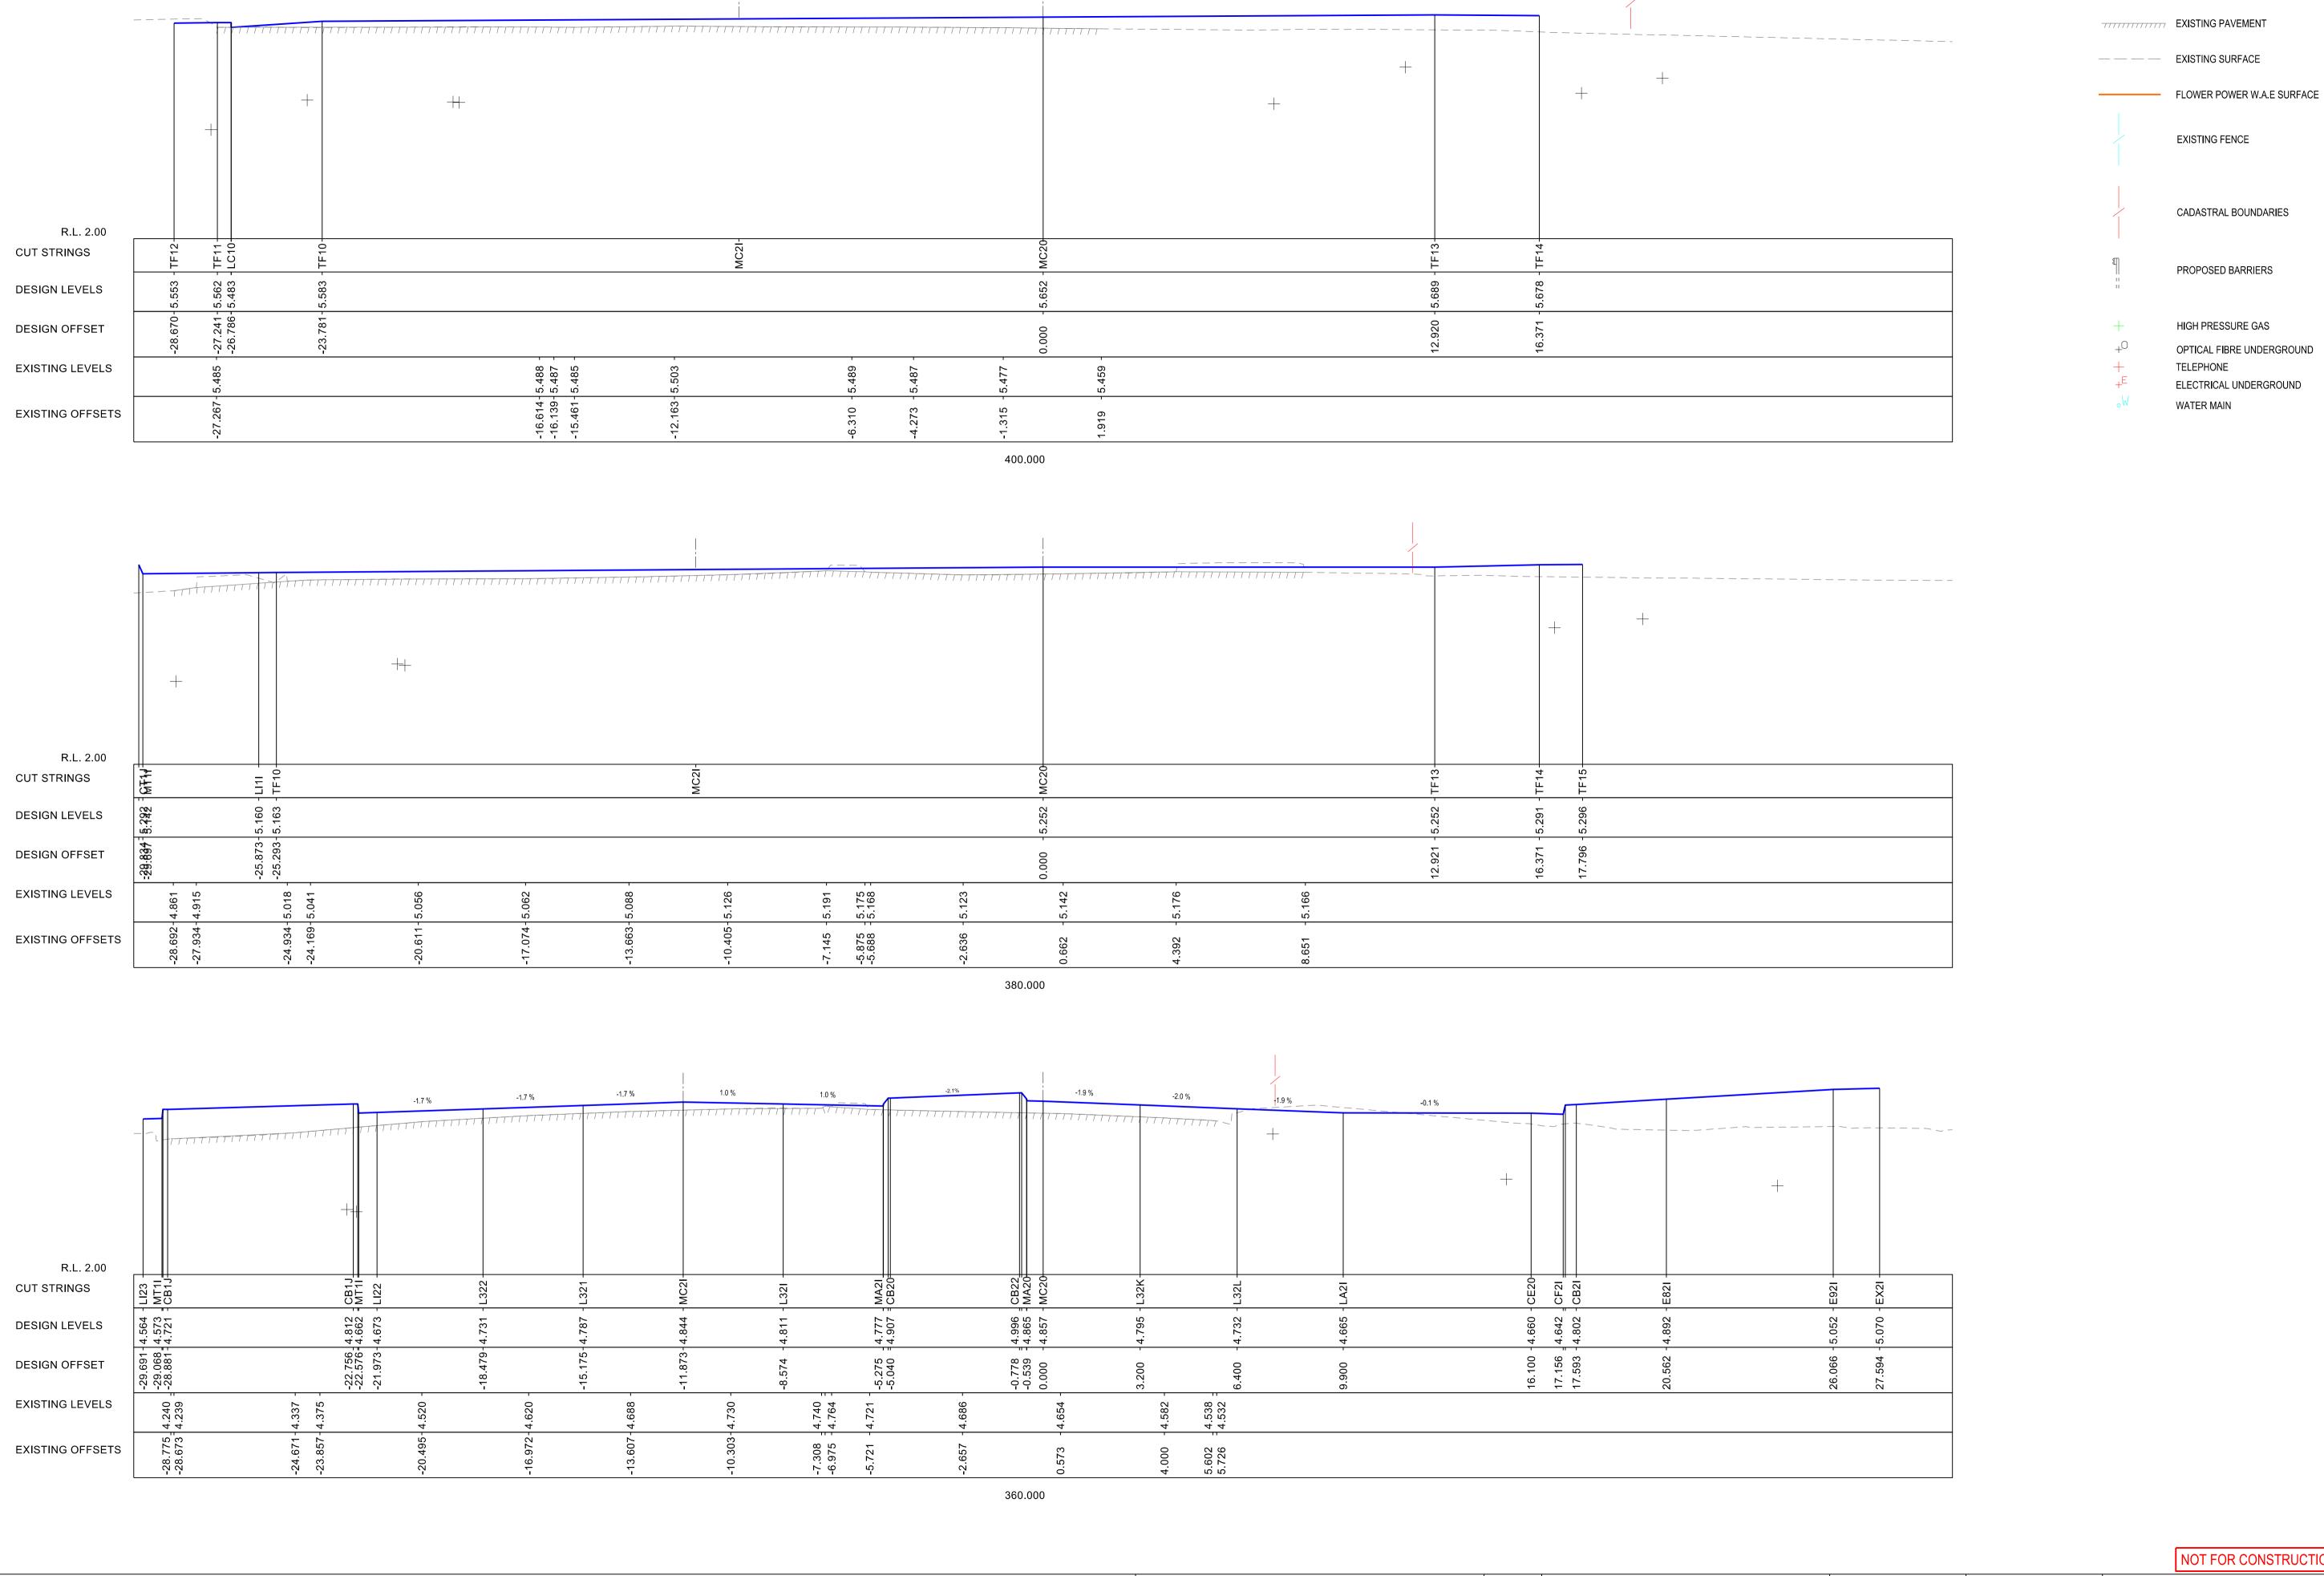

Transport for NSW

LEGEND

———— DESIGN SURFACE


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MR508 HENRY LAWSON DRIVE
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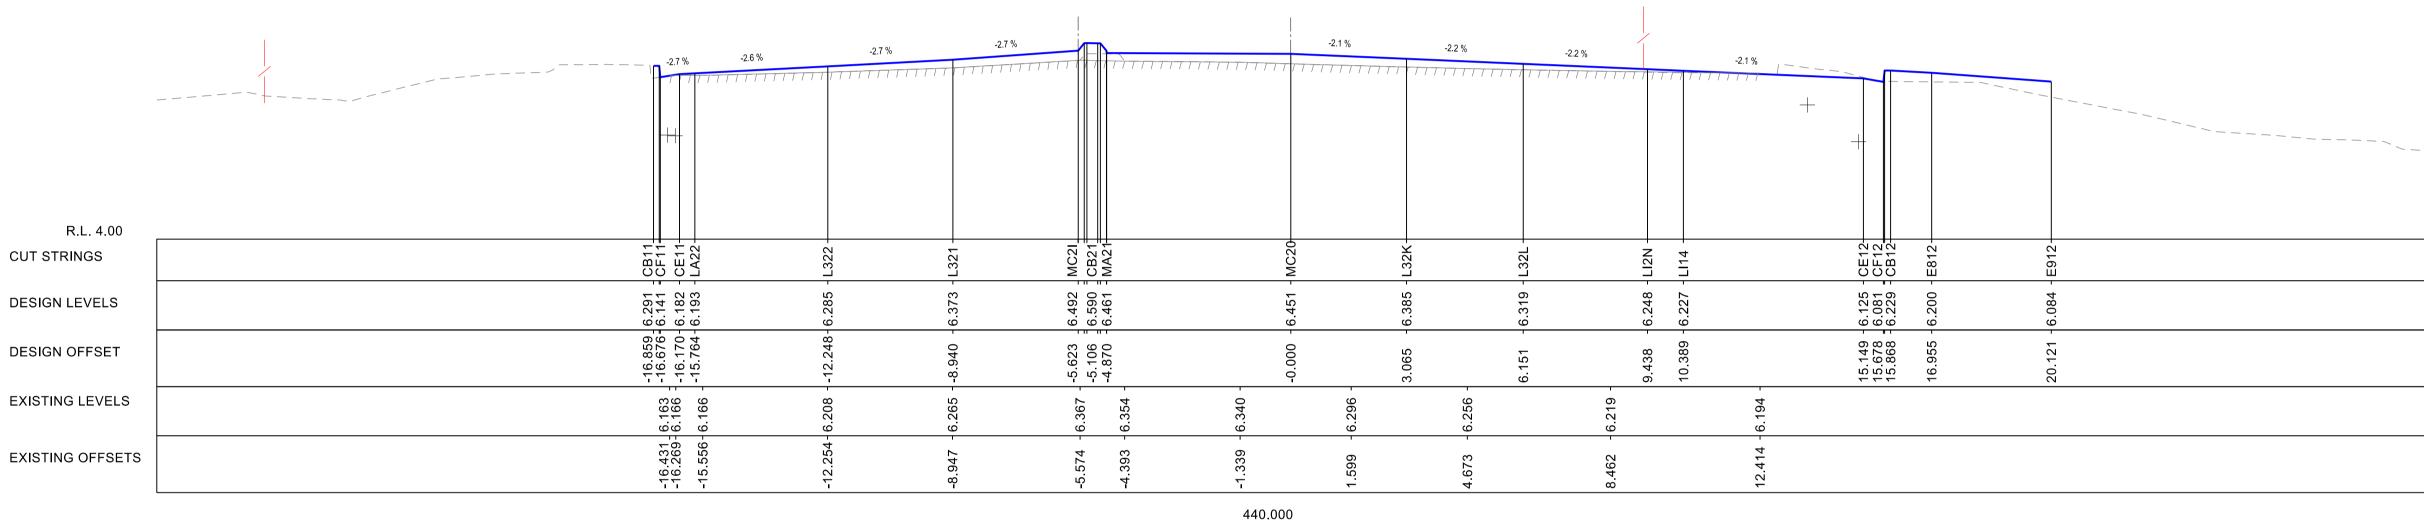
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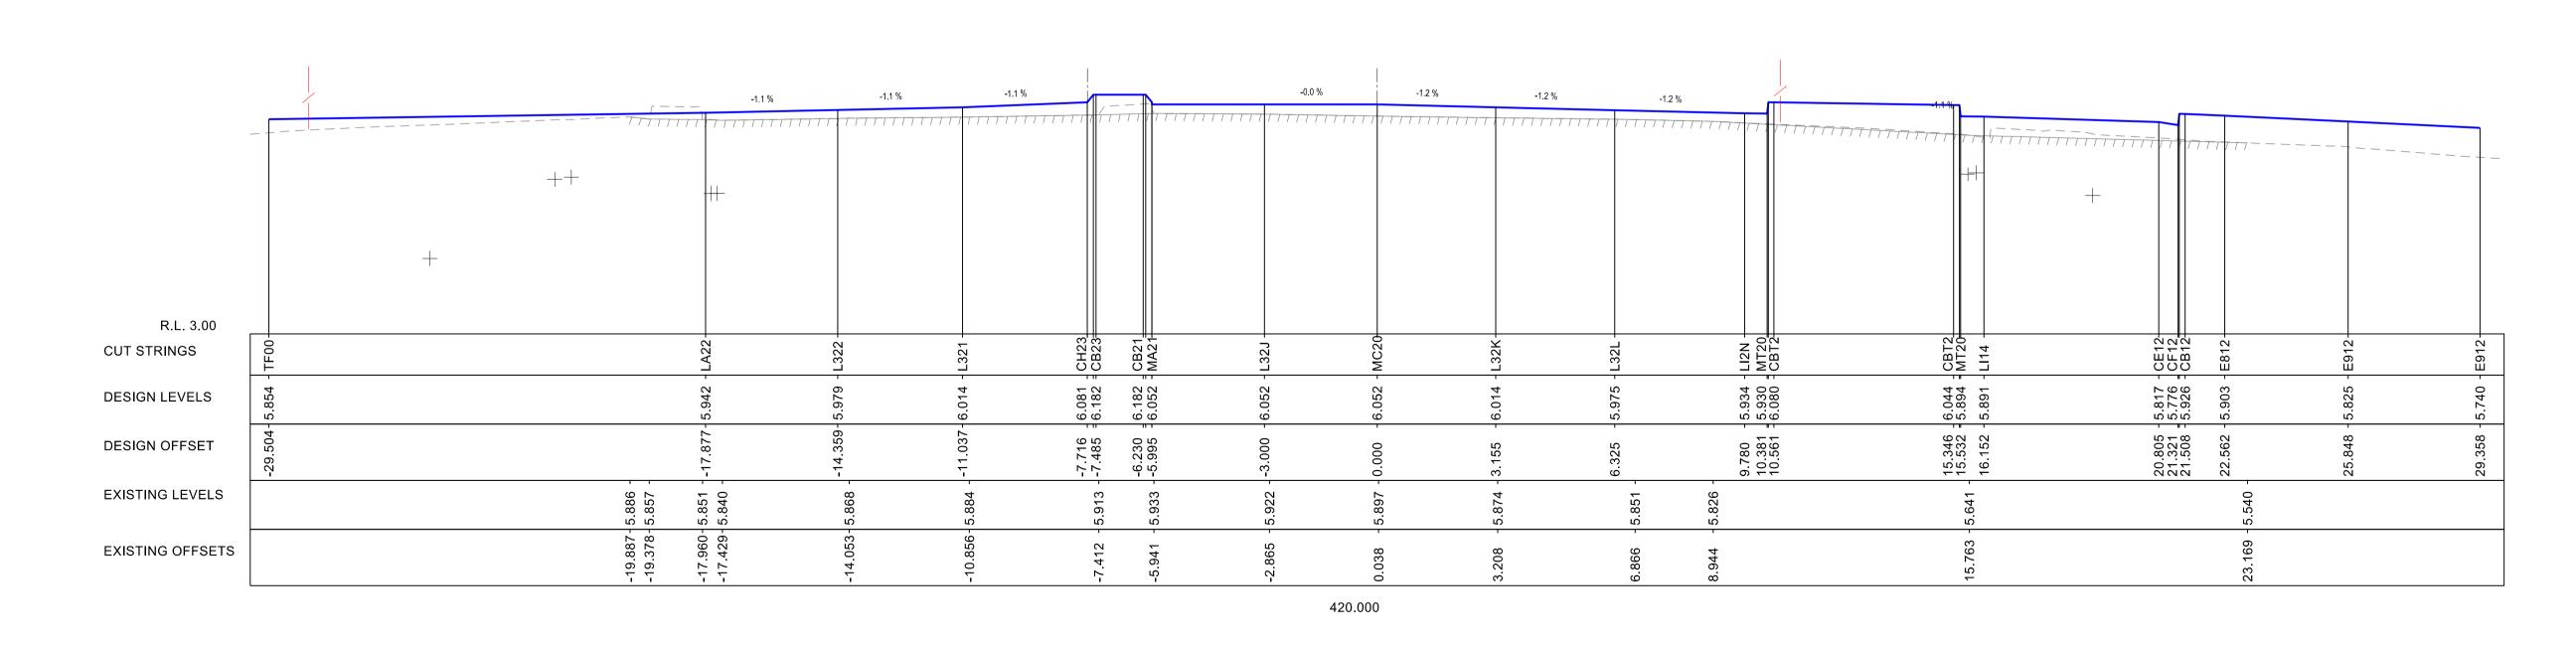
ISSUE STATUS
80% CONCEPT - REFERENCE DESIGN | SF2019/233157 | SF2019/233157 | RC-0028 | A

DESIGN LOT CODE DESIGN MODEL FILE(S) USED FOR DOCUMENTATION OF THIS DRAWING K:1CADD\Design\pds14\Henry Lawson Drive and Milipera Road\Drawings\CAD\Sheet EXTERNAL REFERENCE FILES REV D REV DATE AMENDMENT / REVISION DESCRIPTION 01 04-05-2020 ISSUED FOR 20% DESIGN 02 29-05-2020 ISSUED FOR 50% DESIGN 02 31-08-2020 ISSUED FOR 80% DESIGN CO-ORDINATE SYSTEM HEIGHT DATUM
MGA ZONE 56 (GDA94) AHD

PLOT DATE / TIME 4/09/2020 3:46:55 PM PLOT BY ngukinh TITLE NAME DATE
DATE
DRAWN VINCENT NGUYEN 29.05.20
DRG CHECK BEN CARTWRIGHT 29.05.20
DESIGN MNGR TIM HUFTON 29.05.20
PROJECT MNGR SARAH ABID 29.05.20
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DESIGN MNGR TIM HUFTON 29.05.20

PROJECT MNGR SARAH ABID 29.05.20

SYDNEY NORTH Transport for NSW

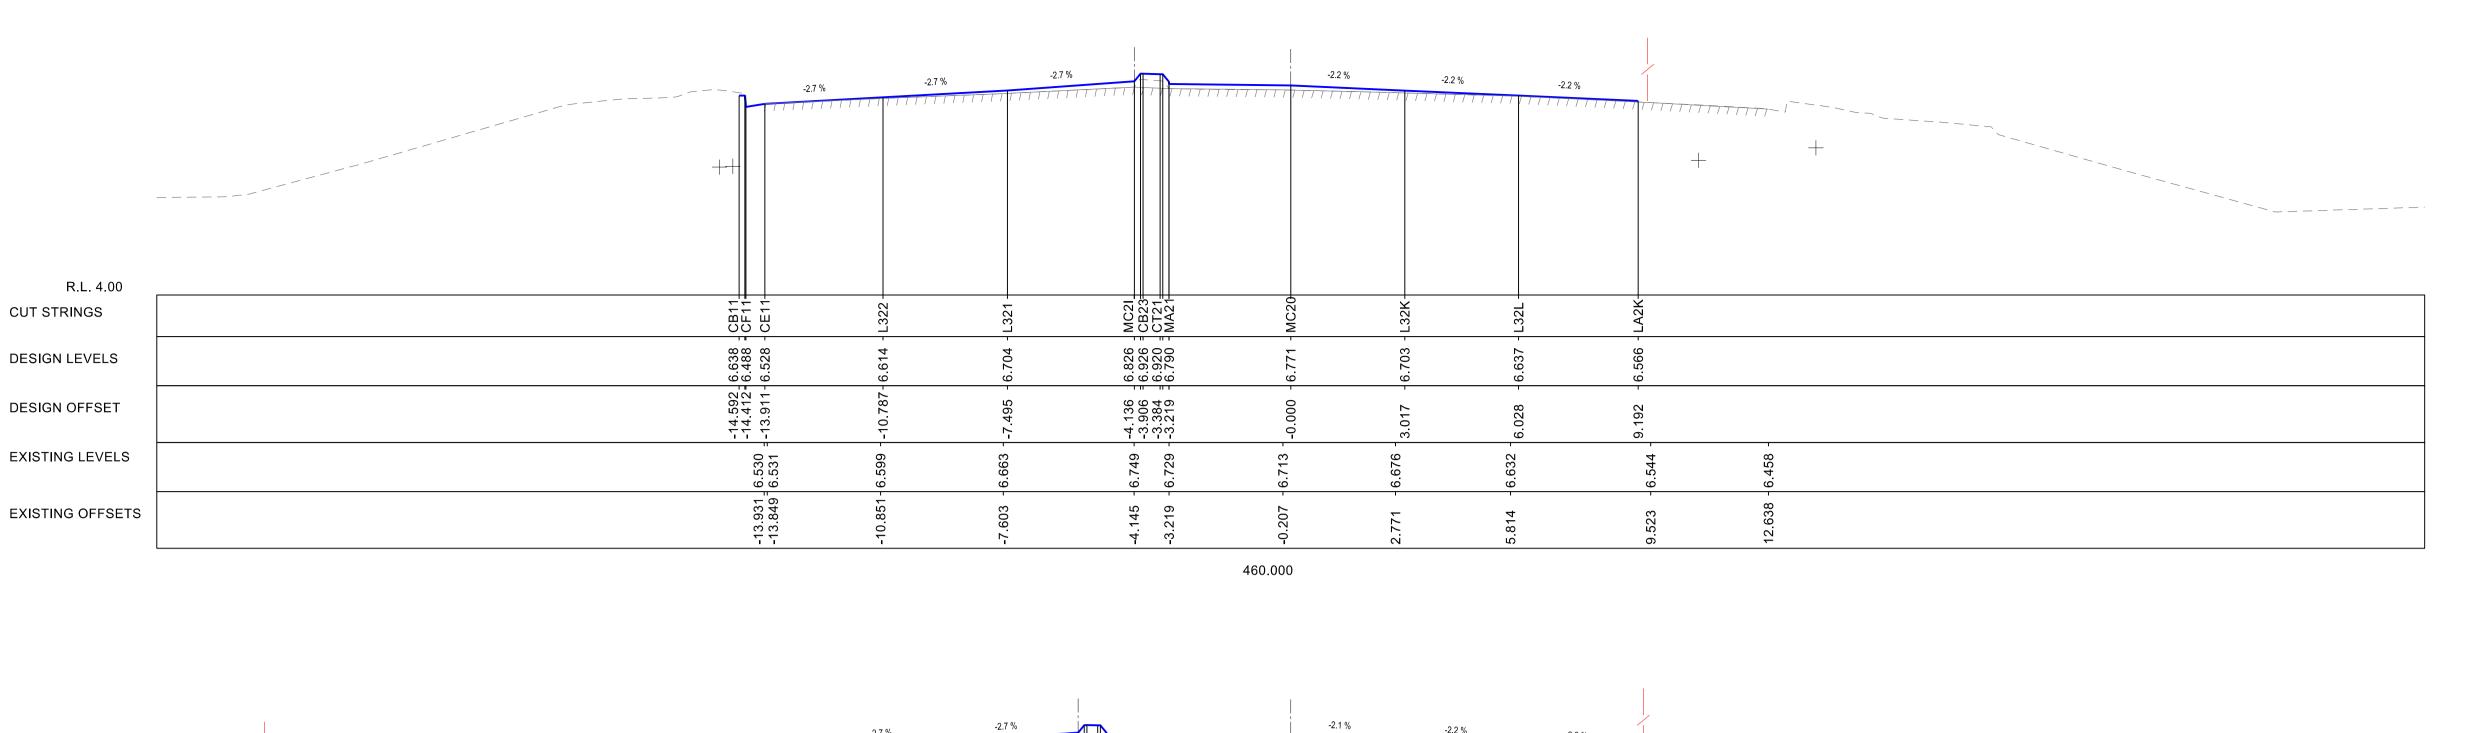PLOT DATE / TIME 4/09/2020 3:46:56 PM

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CO-ORDINATE SYSTEM HEIGHT DATUM MGA ZONE 56 (GDA94) AHD

PLOT BY ngukinh

LEGEND

———— DESIGN SURFACE

------ EXISTING PAVEMENT

— — — EXISTING SURFACE

FLOWER POWER W.A.E SURFACE

CADASTRAL BOUNDARIES

PROPOSED BARRIERS

HIGH PRESSURE GAS

TELEPHONE

WATER MAIN

OPTICAL FIBRE UNDERGROUND

ELECTRICAL UNDERGROUND

EXISTING FENCE

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