

Report on Preliminary Site Investigation (Contamination)

Proposed Rezoning 20 Fetherstone Street and 369 Chapel Road, Bankstown

Prepared for City of Canterbury Bankstown Council

Project 208123.00 December 2021





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The undersigned, on behalf of Douglas Partners Pty Ltd, confirm that this document and all attached drawings, logs and test results have been checked and reviewed for errors, omissions and inaccuracies.

	Signature	Date
Author	#17r	23 December 2021
Reviewer	P. Sormen	23 December 2021





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Report on Preliminary Site Investigation (Contamination) Proposed Rezoning 20 Fetherstone Street and 369 Chapel Road, Bankstown

1. Introduction

Douglas Partners Pty Ltd (DP) has been engaged by City of Canterbury Bankstown Council (Council) to complete this preliminary site investigation for Contamination (PSI) at 20 Fetherstone Street and 369 Chapel Road, Bankstown (the site). The site is shown on Drawing 1, Appendix A.

The investigation was undertaken in accordance with DP's proposal P208123.00.P.001.Rev1 dated 26 August 2021.

Based on the information provided by Council, it is understood that the Bankstown Master Plan was adopted by Council on 28 September 2021. The master plans propose a rezoning of various sites currently zoned SP2 - Special Purpose to B4 Mixed Use and B3 Commercial Core in Bankstown City Centre. This PSI is required to address NSW Government Ministerial Directions on rezoning of land, to confirm whether the site is suitable (or will be suitable, after remediation) for dwellings and other more sensitive land uses than is currently permitted on the site.

The objectives of the PSI are to:

- Address Ministerial Direction 2.6 (Remediation of Contaminated Land);
- Based on site history searches and a brief inspection from publicly accessible areas, identify
 potential sources of contamination on the site;
- Assess potential contamination risks that may preclude rezoning of the site; and
- Comment on the need for further detailed investigation where contamination may be present.

This report must be read in conjunction with all appendices including the notes provided in Appendix B.

The following key guidelines were consulted in the preparation of this report:

- NEPC National Environment Protection (Assessment of Site Contamination) Measure 1999 (as amended 2013) [NEPM] (NEPC, 2013); and
- NSW EPA Guidelines for Consultants Reporting on Contaminated Land (NSW EPA, 2020).

2. Scope of Works

The scope of works for the PSI comprised the following:

- Review of the following site / history information, provided to DP by Council:
 - o Section 10.7 (2&5) Planning Certificates;



- o Council records available under an Informal application under the Government Information (Public Access) Act 2009 (GIPA Act); and
- o Available records / documents on current and historic site use / activities.
- Review of the following site history information / records, obtained by DP:
 - Historical aerial photographs;
 - o SafeWork NSW database search for records of dangerous goods licenses registered to the site:
 - o Historical title deed searches for each lot comprising the site;
 - o NSW EPA databases held under the CLM and POEO Acts for the site and adjoining properties;
 - o Registered groundwater bores;
 - o Regional geological, soil and hydrogeological mapping; and
 - o Acid sulfate soil and salinity risk maps.
- A site walkover to observe and record external appearance of each property, current land uses, signs of historical uses, hydrogeological features (i.e., streams, dams, water wells, catchments and drainage), presence of fill, waste disposal practices, etc. The walkover was undertaken from publicly accessible areas and did not comprise a detailed walkover within the premises unless it was a publicly accessible area;
- Based on the above information identify areas of environmental concern (AEC) and contaminants of potential concern (CoPCs);
- Preparation of a conceptual site model (CSM); and
- Prepare this PSI report.

3. Site Information

Site Address	20 Fetherstone Street and 369 Chapel Road, Bankstown	
Legal Description	Lots B&C, DP 432479	
	Lot 10, DP 5541	
Area	1,068 m ²	
Current Zoning	Zone SP2 Public Administration Building	
Proposed Zoning	Zone B3 Commercial Core	
Local Council Area	City of Canterbury Bankstown Council	
Current Use	Court House	
Surrounding Uses	North - Grassed area, then The Mall (road), then council buildings	
	East - Commercial and retail	
	South - Commercial and retail	
	West - Commercial and retail	





Figure 1: Site Location

4. Environmental Setting

4.1 Topography

The regional topography is generally sloping towards the east to south-east.

Site topography falls gently towards the east, with levels between approximately 24 m on the eastern side and 27 m on the western side of the site relative to Australian Height Datum (AHD).

4.2 Site Geology

The Sydney 1:100,000 Soils Landscape Sheet indicates that the site is underlain by Glenorie erosional soils. The Glenorie soils group comprises shallow to moderately deep red podzolic soils on crests, moderately deep red and brown podzolic soils on upper slopes, deep yellow podzolic soils on lower slopes and humic gleys, yellow podzolic soils and gleyed podzolic soils along drainage lines.



The Sydney 1:100,000 Geology Sheet indicates that the site is underlain by Ashfield Shale. Ashfield Shale comprises black to dark grey shale and laminite.

4.3 Acid Sulphate Soils and Salinity

Published acid sulphate soils (ASS) risk mapping indicates that the site has a low probability of having ASS.

There are no mapped areas of ASS occurrence within 2 km of the site.

Published salinity risk mapping indicates that the site has moderate to high salinity potential.

4.4 Surface Water and Groundwater

The closest watercourse to the site is Salt Pan Creek, located approximately 650 m south (down gradient) of the site, which flows into Georges River. Other watercourses are significantly further from the site. With respect to surface water, given the highly urbanised nature of the area, most surface water is anticipated to be collected by the local stormwater network.

A search of the publicly available registered groundwater bore database indicated that there were no registered wells at the site, or within a 1 km search buffer. The nearest registered groundwater bores are a cluster of nine monitoring bores approximately 1.4 km to the north-east.

Based on regional topography, the anticipated flow direction of groundwater beneath the site is to the south, towards Salt Pan Creek, the likely receiving surface water body for the groundwater flow path. Salt Pan Creek flows into Georges River, which ultimately flows into Botany Bay.

Given the local geology (i.e., Ashfield Shale), the groundwater in the fractured rock beneath the site is anticipated to be saline and very low yield. Accordingly, there would be no significant potential beneficial uses of the groundwater. Furthermore, the search of the groundwater bore database found no domestic, recreational, or irrigational bores within 1 km of the site, and the use of groundwater for these purposes in the vicinity of the site is considered unlikely given the urban setting.

5. Site History

5.1 Title Deeds

A historical title deeds search was used to obtain ownership and occupancy information including company names and the occupations of individuals. The title information can assist in the identification of previous land uses by the company names or the site owners and can, therefore, assist in establishing whether there were potentially contaminating activities occurring at the site. The results of the title deeds search are included in Appendix C. A summary of the title deeds and possible or known land uses is



presented in Tables 1 to 4. Historical aerial photographs (refer Section 5.2) were used to assist in determining land uses.

Table 1: Historical Title Deeds - Lot B, DP 432479 (Part 1) and Lot C, DP 432479

Date of Acquisition and Term Held	Registered Proprietor(s) & Occupations	Inferred Land Use
27.08.1915 (1915 to 1920)	Alfred Herbert Bird (Carpenter)	Unknown
15.04.1920 (1920 to 1945)	William Charles Watson (Builder)	Unknown

Table 2: Historical Title Deeds - Lot B, DP 432479 (Part 2)

Date of Acquisition and Term Held	Registered Proprietor(s) & Occupations	Inferred Land Use
17.08.1915 (1915 to 1917)	Robert William Hatch (Shearer)	Possibly agricultural
20.07.1917 (1917 to 1920)	Annie O'Donnell (Married Woman)	Unknown
10.02.1920 (1920 to 1945)	William Charles Watson (Builder)	Unknown

Table 3: Historical Title Deeds - Lots B&C, DP 432479

Date of Acquisition and Term Held	Registered Proprietor(s) & Occupations	Inferred Land Use
27.06.1945 (1945 to 1948)	Jacques Hochstadt (Apprenticed Mechanic)	Unknown
11.03.1948 (1948 to 1989)	The Minister for Public Works (For and on behalf of King George the Sixth - For Police Purposes)	Police Station
28.04.1989 (1989 to 2004)	Her Most Gracious Majesty Queen Elizabeth The Second (On behalf of the Minister for Police for the Police Department)	Police Station
17.05.2004 (2004 to Date)	Her Most Gracious Majesty Queen Elizabeth The Second (Attorney Department)	Court House



Table 4: Historical Title Deeds - Lot 10, DP 5541

Date of Acquisition and Term Held	Registered Proprietor(s) & Occupations	Inferred Land Use
02.05.1918 (1918 to 1947)	Ellis May Forrester (Spinster)	Unknown
10.04.1947 (1947 to 1989)	Minister for Public Works (for the purposes of a Court House)	Court House
31.10.1989 (1989 to Date)	Her Most Gracious Majesty Queen Elizabeth II on behalf of The Attorney-General for the Attorney- General's Department	Court House

5.2 Historical Aerial Photography

Several historical aerial photographs were obtained from public databases. Extracts of the aerial photographs are included in Appendix D. A summary of key features observed for the site and surrounding land is presented in Table 5.

Table 5: Summary of Historical Aerial Photographs

Year	Site	Surrounding Land Use
1943	The site appeared to comprise empty grassed space. The eastern portion of the site may have contained trees and livestock, however low image resolution precluded a detailed assessment.	The surrounding area appeared to comprise residential buildings to the east and west. To the south were residential buildings followed by commercial or retail buildings, and to the north appeared to contain empty space with sawtooth shaped trenches, possibly for military training purposes (typical shape).
1955	Very low image resolution allowed only a limited assessment. The eastern portion of the site appeared to remain unchanged, while the western portion of the site appeared to have been repurposed as a car park.	Very low image resolution allowed only a limited assessment. No significant changes were observed to the east, west or south. Development appeared to have occurred to the north, however it was unclear what the likely land use may have been.
1961	The entire site appeared to have been cleared and replaced with a larger building occupying the whole site. Based on historical title deeds and council records, this building is likely to have been a police station.	The area to the north of the site appeared to have been cleared, with grassed open space and a road. Some residential buildings to the east, west and south appeared to have been replaced with larger commercial or retail buildings.
1971	No significant changes to the site were observed when compared with the 1961 aerial photograph.	A round building appeared to have been constructed to the north of the site, resembling the current council chambers. A larger building



Year	Site	Surrounding Land Use
		can also be observed to the north-east of the site.
1982	No significant changes to the site were observed when compared with the 1971 aerial photograph.	No significant changes to the site surroundings were observed when compared with the 1971 aerial photograph.
1991	No significant changes to the site were observed when compared with the 1982 aerial photograph.	No significant changes to the site surroundings were observed when compared with the 1982 aerial photograph.
1998	No significant changes to the site were observed when compared with the 1991 aerial photograph.	No significant changes to the site surroundings were observed when compared with the 1991 aerial photograph.
2007	The site appeared to have had a new building constructed, resembling the building currently in place.	No significant changes to the site surroundings were observed when compared with the 1998 aerial photograph.
2016	No significant changes to the site were observed when compared with the 2007 aerial photograph.	No significant changes to the site surroundings were observed when compared with the 2007 aerial photograph.

5.3 Public Registers and Planning Records

EPA Notices available under Section 58 of the Contaminated Lands Management Act (CLM Act) [accessed 7/12/2021]	The results of a search of the public database of records of notices for contaminated sites indicated that there were no records of notices for the site. The search also indicated that there were no records of notices for sites within a 1 km search buffer of the site.
Sites notified to EPA under Section 60 of the CLM Act [accessed 7/12/2021]	The results of a search of the public database of contaminated sites notified to the EPA indicated that the site was not listed as a notified contaminated site. The search also indicated that there were no records of notices for sites within a 1 km search buffer of the site.
Licenses listed under Section 308 of the Protection of the Environment Operations Act 1997 (POEO Act) [accessed 7/12/2021]	The results of a search of the public database or records of environmental protection licences, applications, notices or audits under the POEO Act indicated that there are no current records issued to the site. One site, however, was identified within the 1 km search buffer of the site: KLF Holdings Pty Ltd - 12-14 Dellwood Street, Bankstown, NSW 2200 [950 m south] - s.91 Clean Up Notice.
SafeWork NSW [conducted 10/12/2021]	A search of SafeWork NSW records for Schedule 11 hazardous chemicals on premises detailed a 16500 L underground storage tank (UST) that was decommissioned in 1996 via infilling. There is also reference to a 2000L underground tank, although it is unclear if this is a different tank to the one decommissioned in situ. Refer Appendix E.



Planning Certificate(s) [dated 3/11/2021]	Planning certificates for the site indicate that the council is not aware of the land being affected by any matters as prescribed by Section 59 (2) of the Contaminated Land Management Act 1997. Refer Appendix F.	
Council Records	A review of the available council records indicated a number of documents relating to potential contamination at the site including:	
	 Correspondence with Bankstown City Council (1983) regarding the replacement of an UST at the site, which was a police station at the time. Plans attached to this correspondence also indicate that some components associated with the tank contained asbestos. 	
	 A letter from Council (2003) regarding a development application. The letter notes that a UST may have been removed at some point, but questions whether additional USTs may be present at the site. 	

5.4 Other Sources

A brief search of Google maps on 7 December 2021 for potentially contaminating activities (such as 'dry cleaners' or 'mechanic' etc.) in the surrounding area located six potentially contaminating operating activities within a 500 m buffer zone of the site:

- Bankstown Drycleaners & Alteration [60 m south-west];
- Valet Dry Clean [100 m south];
- Mr. Dry Clean & Sons [100 m south];
- Royce Cleaning [160 m south-east];
- mycar Tyre & Auto Bankstown [390 m north-east]; and
- Pink Slip Today Bankstown [320 m south-east]

5.5 Site History Integrity Assessment

The information used to establish the history of the site was sourced from reputable and reliable reference documents, many of which were official records held by Government departments / agencies. The databases maintained by various Government agencies potentially can contain high quality information, but some of these do not contain any data at all.

In particular, aerial photographs provide generally high quality information that is generally independent of memory or documentation. They are only available at intervals of several years, so some gaps exist in the information from this source. The observed site features are open to different interpretations and can be affected by the time of day and / or year at which they were taken, as well as specific events, such as flooding. Care has been taken to consider different possible interpretations of aerial photographs and to consider them in conjunction with other lines of evidence.



5.6 Summary of Site History

The historical aerial photographs suggest that the site was empty grassed space from at least 1943 until the 1950s. Land use for the site at this time is unclear, however it is possible that the western portion of the site was used as a car park and that livestock were kept in the eastern portion of the site. From the 1950s until the 2000s the site appeared to have been used as a police station, and the site appears to have been used as a court house since the 2000s. Historical aerial photographs also indicate that the surrounding area was predominantly residential around the 1940s with a possible military training facility to the north, and commercial and retail development gradually occurring over time.

A search of properties with EPA notices and licences and review of Section 10.7 Planning Certificates did not identify the site to be notified to the EPA as contaminated, be regulated under the CLM Act, or hold a licence or have received any EPA notices. One site was identified within a 1 km buffer of having received a clean up notice from the EPA. However, given that the notice related to possible asbestos contamination and given the distance between sites, this is not considered to pose significant environmental risk to the site. A review of the SafeWork NSW Schedule 11 hazardous chemicals on premises for the site and council records also identified a decommissioned underground storage tank and associated asbestos componentry within the site.

Additionally, a brief Google maps search of the local area located four dry cleaning facilities and two car mechanics within a 500 m search buffer of the site.

6. Site Walkover

A site walkover was undertaken by an environmental scientist on 29 November 2021, observing from the public areas surrounding the site. The general site topography was consistent with that described in Section 4.1. The site layout appears to have remained unchanged from the 2016 aerial photograph. The following key site features pertinent to the PSI were observed (refer to photographs in Appendix G).

- The site was a court house;
- The majority of the site was occupied by a building, surrounded by a paved footpath;
- To the north of the site was a grassed area, then a road, then council buildings; and
- To the south, west and east of the site were roads and commercial and retail buildings.

7. Preliminary Conceptual Site Model

A Conceptual Site Model (CSM) is a representation of site-related information regarding contamination sources, receptors and exposure pathways between those sources and receptors. The CSM provides the framework for identifying how the site became contaminated and how potential receptors may be exposed to contamination either in the present or the future i.e., it enables an assessment of the potential source - pathway - receptor linkages (complete pathways).



Potential Sources

Based on the current investigation, the following potential sources of contamination and associated contaminants of potential concern (COPC) have been identified.

- S1: Fill: Associated with levelling, demolition of former buildings on the site and backfilling (a common characteristic of Sydney suburbs):
 - o COPC include metals, total recoverable hydrocarbons (TRH), benzene, toluene, ethylbenzene, xylene (BTEX), polycyclic aromatic hydrocarbons (PAH), polychlorinated biphenyls (PCB), organochlorine pesticides (OCP), phenols and asbestos.
- S2: Former buildings and structures on the site:
 - o COPC include hazardous building materials such as asbestos containing materials (ACM), lead (in paint), synthetic mineral fibres (SMF) and polychlorinated biphenyls (PCB).
- S3: USTs and associated pipework, bowsers and asbestos containing componentry:
 - o COPC include lead, TRH, BTEX, PAH, volatile organic compounds (VOC) and asbestos.
- S4: Previous use as a car park and police station:
 - o COPC include metals, TRH, BTEX, PAH, phenols and VOCs.
 - S5: Possible agricultural use: COPC include arsenic, OCP, OPP.
- S6: Nearby dry cleaners:
 - o COPC include trichlorethylene, 1,1,1-trichloroethane, carbon tetrachloride and perchlorethylene (PERC).
- S7: Nearby mechanics:
 - o COPC include metals, TRH, BTEX, PAH, phenols and VOCs.
- S8: Possible nearby military training:
 - o COPC include those associated with explosives, engine works and per- and polyfluoroalkyl substances (PFAS).

Potential Receptors

The following potential human receptors have been identified:

- R1: Current users [court house];
- R2: Construction and maintenance workers;
- R3: End users [commercial]; and
- R4: Adjacent site users [commercial and retail].

The following potential environmental receptors have been identified:

- R5: Surface water [Salt Pan Creek];
- R6: Groundwater; and
- R7: Terrestrial ecology.



Potential Pathways

The following potential pathways have been identified:

- P1: Ingestion and dermal contact;
- P2: Inhalation of dust and / or vapours;
- P3: Surface water run-off;
- P4: Lateral migration of groundwater providing base flow to water bodies;
- P5: Leaching of contaminants and vertical migration into groundwater; and
- P6: Contact with terrestrial ecology.

Summary of Potentially Complete Exposure Pathways

A 'source-pathway-receptor' approach has been used to assess the potential risks of harm being caused to human or environmental receptors from contamination sources on or in the vicinity of the site, via exposure pathways (potential complete pathways). The possible pathways between the above sources (S1 to S8) and receptors (R1 to R7) are provided in below Table 6.

Table 6: Summary of Potentially Complete Exposure Pathways

Source and COPC	Transport Pathway	Receptor	Risk Management Action
S1: Fill, Metals, TRH, BTEX, PAH, OCP, phenols	P1: Ingestion and dermal contact	R2: Construction and maintenance workers	An intrusive investigation is recommended to
and asbestos S3: USTs, Lead, TRH, BTEX, PAH, VOCs and asbestos	P2: Inhalation of dust and/or vapours	R1: Current users [court house] R2: Construction and maintenance workers R3: End users	assess the presence or otherwise of identified potential sources and/or the contaminants
S4: Car park and police station,		[commercial]	associated with
Metals, TRH, BTEX, PAH, phenols and VOCs S5: Previous agricultural use	P4: Lateral migration of groundwater providing base flow to water bodies P5: Leaching of contaminants and vertical migration into groundwater	R5: Surface water [Salt Pan Creek] R6: Groundwater	those sources. The investigation is recommended to include soil, groundwater and soil vapour sampling and
S6: Dry cleaners (see potential sources above)	P6: Contact with terrestrial ecology	R7: Terrestrial ecology	testing.
S7: Mechanics, Metals, TRH, BTEX, PAH, phenols and VOCs			



Source and COPC	Transport Pathway	Receptor	Risk Management Action
S8: Military training, Explosives, metals, TRH, BTEX, PAH, phenols, VOCs, PFAS			
S2: Former buildings, Asbetos, SMF, lead, PCB	P1: Ingestion and dermal contact	R2: Construction and maintenance workers	
	P2: Inhalation of dust and/or vapours	R2: Construction and maintenance workers	
	P6: Contact with terrestrial ecology	R7: Terrestrial ecology	

8. Risk Rating

Based on the preliminary CSM and using the methodology outlined in Appendix H, a qualitative risk rating for the identified contamination sources has been developed.

Table 7 presents the results of the application of the risk matrix (Appendix H) to each identified potential AEC.

Table 7: AEC Risk Rating

AEC	AEC Description	Probability	Consequence	Risk Number
S1	Fill	3	2	6
S2	Former Buildings	3	2	6
S3	USTs	3	5	15
S4	Car park / police station	2	2	4
S5	Agricultural use	1	2	2
S6	Dry cleaners	1	3	3
S7	Mechanics	1	3	3
S8	Military training	1	3	3
			Site Risk Rating	15



9. Conclusions and Recommendations

Based on the available site history information, the site appears to have had residential or possibly agricultural land use from at least 1943 until the 1950s, when the western portion of the site appeared to be repurposed as an open-air car park. The site then appears to have been used as a police station, and has been used as a court house since the 2000s. Surrounding land use appears to have included residential, commercial, retail, possible military training, dry cleaning and car mechanics. SafeWork NSW Schedule 11 hazardous chemicals on premises search and council records also indicate the presence of at least one decommissioned underground storage tank at the site.

Potential sources of contamination identified in this investigation include imported fill, former buildings / structures, the underground storage tank(s), previous use as a car park and police station, previous agricultural use, nearby dry cleaning and mechanics, and possible nearby military training. Based on the review of results of this PSI, and in accordance with the process outlined in Appendix H, the site has been assigned a contamination risk rating of 15, corresponding to a high risk.

As the current investigation was limited to a desktop study, comments on the actual contamination status of the site cannot be provided unless intrusive investigations are undertaken to obtain quantitative data on the contamination status of the soil and groundwater. Notwithstanding, the desktop results to date suggest that the identified sources of potential contamination and assigned contamination risk for the site are not necessarily uncommon when compared to other similar properties in urban settings. Accordingly, based on the results of this PSI, the following is recommended:

• Detailed Site Investigation - A detailed site investigation (DSI) for contamination with intrusive soil and groundwater / soil vapour (potentially) sampling to evaluate the potential contamination status of the site and assess the site's suitability (from a contamination standpoint) for a more sensitive land use. In addition, the DSI should provide recommendations on the need for any further targeted investigation(s) and / or site remediation if deemed necessary. As the details of the proposed development are not known at this stage, the DSI could be undertaken around the Development Application (DA) stage i.e., when particulars of the proposed development are known.

Based on the results of the PSI, it is considered that the site can be made suitable for the proposed B3 Commercial Core rezoning subject to implementation of the recommended investigations and remediation and / or management of contamination that may be identified from the investigations.

Whilst the extent and need for remediation, if any, will be dependent on the results of the intrusive investigation/s and the details of the proposed development, typical soil remediation options that may be viable (to be selected or revised based on type of contamination identified) have been provided below for information purposes only:

- Excavation and Offsite Disposal Excavation of the impacted fill and off-site disposal to a suitably
 licensed landfill. Subject to complete removal (and validation) of the contamination source
 (including groundwater remediation if required), this option could likely render the site compatible
 with a proposed land use without the need for long term management strategies; or
- Capping and containment: This option typically comprises placement of a geotextile marker layer (such as bidum) over the contaminated profile and subsequently placement / installation of a layer of suitable capping material such as verified clean fill, or a permanent engineered pavement over the contaminated fill with a view to limiting the exposure of site users to contaminants. A physical barrier will require the preparation of and compliance with an Environmental Management Plan (EMP) for long term management of the capping layer, with provisions made for regular inspection



and maintenance if necessary. Furthermore, a cap and contain remediation strategy will need to have an appropriate mechanism for public notification of any restrictions applying to the land to ensure that potential purchasers or other interested individuals are aware of the restrictions (e.g., appropriate notations on a planning certificate issued under Section 10.7 of the Environmental Planning and Assessment Act 1979 or a covenant registered on the title to land under section 88B of the Conveyancing Act 1919).

Remediation options for groundwater, if required, would be dependent on the results of the DSI and the nature and extent of groundwater contamination (if any).

10. References

NEPC. (2013). National Environment Protection (Assessment of Site Contamination) Measure 1999 (as amended 2013) [NEPM]. Australian Government Publishing Services Canberra: National Environment Protection Council.

NSW EPA. (2020). *Guidelines for Consultants Reporting on Contaminated Land.* Contaminated Land Guidelines: NSW Environment Protection Authority.

11. Limitations

Douglas Partners (DP) has prepared this report (or services) for this project at 20 Fetherstone Street and 369 Chapel Road, Bankstown in accordance with DP's proposal dated 26 August 2021 and acceptance received from Liam Rogers dated 26 August 2021. The work was carried out under DP's Conditions of Engagement. This report is provided for the exclusive use of City of Canterbury Bankstown Council for this project only and for the purposes as described in the report. It should not be used by or relied upon for other projects or purposes on the same or other site or by a third party. Any party so relying upon this report beyond its exclusive use and purpose as stated above, and without the express written consent of DP, does so entirely at its own risk and without recourse to DP for any loss or damage. In preparing this report DP has necessarily relied upon information provided by the client and/or their agents.

The results provided in the report are indicative of the sub-surface conditions on the site only at the specific sampling and/or testing locations, and then only to the depths investigated and at the time the work was carried out. Sub-surface conditions can change abruptly due to variable geological processes and also as a result of human influences. Such changes may occur after DP's field testing has been completed.

DP's advice is based upon the conditions encountered during this investigation. The accuracy of the advice provided by DP in this report may be affected by undetected variations in ground conditions across the site between and beyond the sampling and/or testing locations. The advice may also be limited by budget constraints imposed by others or by site accessibility.

The assessment of atypical safety hazards arising from this advice is restricted to the (geotechnical / environmental / groundwater) components set out in this report and based on known project conditions



and stated design advice and assumptions. While some recommendations for safe controls may be provided, detailed 'safety in design' assessment is outside the current scope of this report and requires additional project data and assessment.

This report must be read in conjunction with all of the attached and should be kept in its entirety without separation of individual pages or sections. DP cannot be held responsible for interpretations or conclusions made by others unless they are supported by an expressed statement, interpretation, outcome or conclusion stated in this report.

This report, or sections from this report, should not be used as part of a specification for a project, without review and agreement by DP. This is because this report has been written as advice and opinion rather than instructions for construction.

Douglas Partners Pty Ltd

Appendix A

Drawing





LOCALITY MAP

Notes:

1. Basemap from Metromap.com (dated

30/07/2021)
2. Site boundary shown is approximate only

Legend

Site Boundary

0 15 30 45 60 m



CLIENT: City of Canterbury Bankstown

OFFICE: Sydney DRAWN BY: ZW

SCALE: 1:800 @ A3 DATE: 03.12.2021

TITLE: Site Location Plan

Proposed Rezoning
20 Fetherstone Street and 369 Chapel Road, Bankstown

	PROJECT No:	208123.00
/Ň/)	DRAWING No:	1
	REVISION:	1
\sim		

Appendix B

Notes About this Report

About this Report

Introduction

These notes have been provided to amplify DP's report in regard to classification methods, field procedures and the comments section. Not all are necessarily relevant to all reports.

DP's reports are based on information gained from limited subsurface excavations and sampling, supplemented by knowledge of local geology and experience. For this reason, they must be regarded as interpretive rather than factual documents, limited to some extent by the scope of information on which they rely.

Copyright

This report is the property of Douglas Partners Pty Ltd. The report may only be used for the purpose for which it was commissioned and in accordance with the Conditions of Engagement for the commission supplied at the time of proposal. Unauthorised use of this report in any form whatsoever is prohibited.

Borehole and Test Pit Logs

The borehole and test pit logs presented in this report are an engineering and/or geological interpretation of the subsurface conditions, and their reliability will depend to some extent on frequency of sampling and the method of drilling or excavation. Ideally, continuous undisturbed sampling or core drilling will provide the most reliable assessment, but this is not always practicable or possible to justify on economic grounds. In any case the boreholes and test pits represent only a very small sample of the total subsurface profile.

Interpretation of the information and its application to design and construction should therefore take into account the spacing of boreholes or pits, the frequency of sampling, and the possibility of other than 'straight line' variations between the test locations.

Groundwater

Where groundwater levels are measured in boreholes there are several potential problems, namely:

 In low permeability soils groundwater may enter the hole very slowly or perhaps not at all during the time the hole is left open;

- A localised, perched water table may lead to an erroneous indication of the true water table;
- Water table levels will vary from time to time with seasons or recent weather changes. They may not be the same at the time of construction as are indicated in the report;
- The use of water or mud as a drilling fluid will mask any groundwater inflow. Water has to be blown out of the hole and drilling mud must first be washed out of the hole if water measurements are to be made.

More reliable measurements can be made by installing standpipes which are read at intervals over several days, or perhaps weeks for low permeability soils. Piezometers, sealed in a particular stratum, may be advisable in low permeability soils or where there may be interference from a perched water table.

Reports

The report has been prepared by qualified personnel, is based on the information obtained from field and laboratory testing, and has been undertaken to current engineering standards of interpretation and analysis. Where the report has been prepared for a specific design proposal, the information and interpretation may not be relevant if the design proposal is changed. If this happens, DP will be pleased to review the report and the sufficiency of the investigation work.

Every care is taken with the report as it relates to interpretation of subsurface conditions, discussion of geotechnical and environmental aspects, and recommendations or suggestions for design and construction. However, DP cannot always anticipate or assume responsibility for:

- Unexpected variations in ground conditions.
 The potential for this will depend partly on borehole or pit spacing and sampling frequency:
- Changes in policy or interpretations of policy by statutory authorities; or
- The actions of contractors responding to commercial pressures.

If these occur, DP will be pleased to assist with investigations or advice to resolve the matter.

About this Report

Site Anomalies

In the event that conditions encountered on site during construction appear to vary from those which were expected from the information contained in the report, DP requests that it be immediately notified. Most problems are much more readily resolved when conditions are exposed rather than at some later stage, well after the event.

Information for Contractual Purposes

Where information obtained from this report is provided for tendering purposes, it is recommended that all information, including the written report and discussion, be made available. In circumstances where the discussion or comments section is not relevant to the contractual situation, it may be appropriate to prepare a specially edited document. DP would be pleased to assist in this regard and/or to make additional report copies available for contract purposes at a nominal charge.

Site Inspection

The company will always be pleased to provide engineering inspection services for geotechnical and environmental aspects of work to which this report is related. This could range from a site visit to confirm that conditions exposed are as expected, to full time engineering presence on site.

Appendix C

Historical Title Deeds



ABN: 36 092 724 251 Ph: 02 9099 7400 (Ph: 0412 199 304)

Level 14, 135 King Street, Sydney Sydney 2000 GPO Box 4103 Sydney NSW 2001 DX 967 Sydney

Summary of Owners Report

Address: - Fetherstone Street, Bankstown 2200

Description: - Lots B & C in D.P. 432479

As regards the part numbered (1) on the attached Cadastral Record Enquiry report and also Lot C D.P. 432479.

Date of Acquisition and term held	Registered Proprietor(s) & Occupations where available	Reference to Title at Acquisition and sale
27.08.1915 (1915 to 1920)	Alfred Herbert Bird (Carpenter)	Vol 2601 Fol 179
15.04.1920 (1920 to 1945)	William Charles Watson (Builder)	Vol 2601 Fol 179

As regards the part numbered (2) on the attached Cadastral Record Enquiry report

Date of Acquisition and term held	Registered Proprietor(s) & Occupations where available	Reference to Title at Acquisition and sale
17.08.1915 (1915 to 1917)	Robert William Hatch (Shearer)	Vol 2598 Fol 43
20.07.1917 (1917 to 1920)	Annie O'Donnell (Married Woman)	Vol 2598 Fol 43
10.02.1920 (1920 to 1945)	William Charles Watson (Builder)	Vol 2598 Fol 43

As regards the whole of Lots B & C in D.P. 432479

Date of Acquisition and term held	Registered Proprietor(s) & Occupations where available	Reference to Title at Acquisition and sale
27.06.1945 (1945 to 1948)	Jacques Hochstadt (Apprenticed Mechanic)	Vol 2601 Fol 179 & Vol 2598 Fol 43 Now Vol 5687 Fol 163
11.03.1948 (1948 to 1989)	The Minister for Public Works (For and on behalf of King George the Sixth - ? For Police Purposes)	Vol 5687 Fol 163
28.04.1989 (1989 to 2004)	Her Most Gracious Majesty Queen Elizabeth The Second (On behalf of the Minister for Police for the Police Department)	Vol 5687 Fol 163 Now Auto Consol 5687-163
17.05.2004 (2004 to Date)	Her Most Gracious Majesty Queen Elizabeth The Second (Attorney Department)	Auto Consol 5687-163

Denotes current registered proprietor

Leases & Easements: - NIL


Yours Sincerely Harrison Byrne (Checked by Mark Groll) 22nd November 2021



Cadastral Records Enquiry Report: Lot B DP 432479

Parish: BANKSTOWN

Locality: BANKSTOWN LGA: CANTERBURY-BANKSTOWN **County: CUMBERLAND**

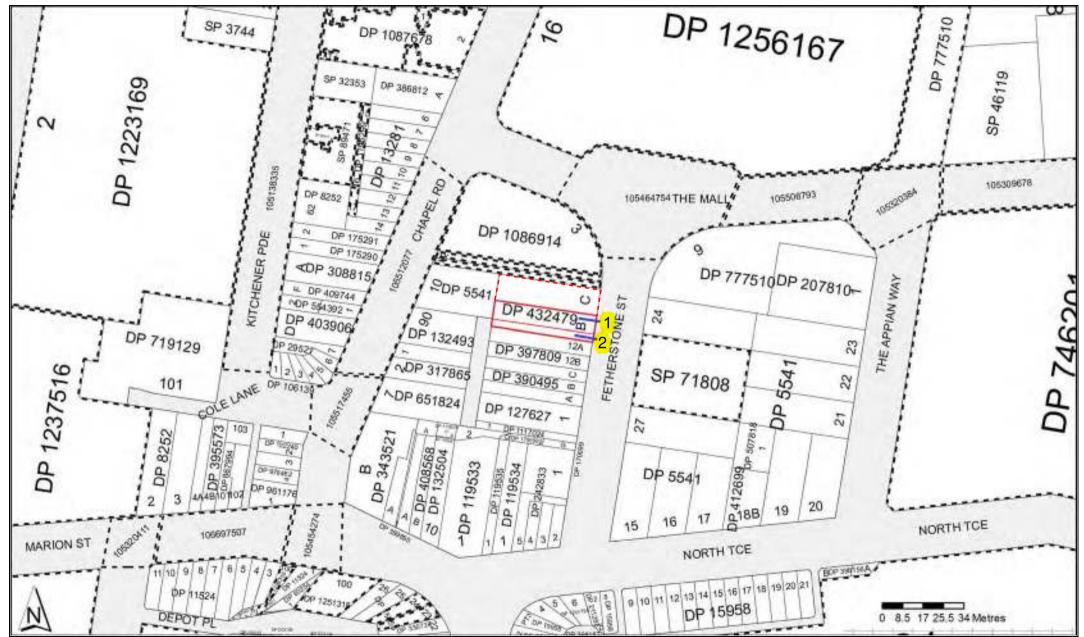

Ref: Bankstown 432479

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CONVERSION TABLE ADDED IN DEPARTMENT OF LANDS DP 432479 FEET INCHES METRES 4.267 10.992 12.192 15.240 18.929 18.936 30.480 34.169 34.176 42.672 14 36 40 50 62 100 112 112 140 0 3/4 1 1/4 1 1/2 1 1/4 1 1/2 SQ M - - 18 1/2 - - 20 1/2 467.9 518.5

Req:R936631 /Doc:DP 0432479 P /Rev:17-Nov-1992 /NSW LRS /Pgs:ALL /Prt:18-Nov © Office of the Registrar-General /Src:INFOTRACK /Ref:Bankstown 432479

† N.B.—Section 117 requires that the above Certificate be signed by Transferee or his Solicitor, and renders any person falsely or negligently certifying liable to a penalty of 150; also to damages recoverable by parties injured. Unless the instrument contains some special covenant by the transferee, the solicitor may sign in cases where it is established that the transferee's signature cannot be obtained without difficulty. The Solicitor must sign his own name and not that of his firm.

^{*} If signed by virtue of any power of attorney, the original power must be registered, and produced with each dealing, and the memorandum of non-revocation on page 2 signed by the attorney before a witness.

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© Office of the Registrar-General /Src:INFOTRACK /Ref:harrison OFFICE UBL ONLY



LAND Historical REGISTRY SERVICES Title



NEW SOUTH WALES LAND REGISTRY SERVICES - HISTORICAL SEARCH

FOLIO: B/432479D

First Title(s): SEE PRIOR TITLE(S) Prior Title(s): VOL 5687 FOL 163

FOLIO NOT CREATED

CONVERTED TO CONSOL CREATED AUTO CONSOL 5687-163 CT NOT ISSUED

*** END OF SEARCH ***

Bankstown 432479

PRINTED ON 18/11/2021

Received: 18/11/2021 17:33:24



LAND Historical **Title**



NEW SOUTH WALES LAND REGISTRY SERVICES - HISTORICAL SEARCH□

SEARCH DATE□ _____ 19/11/2021 11:00AM□

FOLIO: AUTO CONSOL 5687-163 ----

Number Recorded

Type of Instrument

C.T. Issue□

10/5/1993

CONSOL HISTORY RECORD CREATED FOR AUTO CONSOL 5687-163

PARCELS IN CONSOL ARE: B-C/432479.□

24/8/1999 6126437

DEPARTMENTAL DEALING

17/5/2004 AA630036 REQUEST

EDITION 1

*** END OF SEARCH ***

Bankstown 432479

PRINTED ON 19/11/2021

Received: 19/11/2021 11:00:14

Req:R939238 /Doc:DL AA630036 /Rev:19-May-2004 /NSW LRS /Pgs:ALL /Prt:19-Nov-2021 11:00 /Seq:1 of 1 © Office of the Registrar-General /Src:INFOTRACK /Ref:Bankstown 432479 | Form: 11R REQUEST Release: 1.1 **New South Wales** www.lpi.nsw.gov.au Real Property Act 1900 PRIVACY NOTE: this information is legally required and will become part of the public record

If applicable. Office of Grave Revenue use only (A) STAMP DUTY I. X. KNIGHT Orown Solicitor ΜA (B) LAND Torrens Title Number Torrens Title REGISTERED **DEALING** (D) LODGED BY Name, Address or DX and Telephone CODE Delivery Box IV KNIGHT, STATE CROWN SOLICITOR LEVEL 5, 60-70 ELIZABETH STREET, SYDNEY NSW 2000 813E DX 19 SYDNEY Reference (optional): AGD010.8998/T10/DAT (E) APPLICANT (F) NATURE OF Adjust the entry of the folio of the Register to reflect the change in REQUEST administrative arrangements in respect of the above Crown Land. (G) TEXT OF REQUEST The Registrar-General is hereby requested to adjust the entry on the relevant Folio of the Register, in respect of the abovementioned land, to reflect the fact that the Attorney General and his Department will now administer the Land on behalf of the Crown instead of the Minister for Police for the Police Department, effective from 4 May 2004. Accordingly it is requested the name of the Registered Proprietor be amended so that it reads "Her Most Gracious Majesty Queen Elizabeth the Second (Attorney General's Department)".

DATE 6 MAY 2004

Certified for the purposes of the Real Property Act 1900 by the person whose signature appears below.

IAN VICTOR KNIGHT, STATE CROWN SOLICITOR, ON HIS BEHALE BY:

Signature:

Val. 5687-163 CT SIGHTED CANC. & RET. 128121

Signatory's name: DANIELA MARIA RERRUSO
Signatory's capacity: SOLICITOR FOR APPLICANT

All handwriting must be in block capitals.

(pp. 900 38)

Page 1 of

LAND AND PROPERTY INFORMATION NSW

Rep 56



NEW SOUTH WALES LAND REGISTRY SERVICES - TITLE SEARCH

FOLIO: AUTO CONSOL 5687-1630

 SEARCH DATE
 TIME
 EDITION NO
 DATE

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 18/11/2021
 5:32 PM
 1
 17/5/2004

 $\mathtt{LAND}\square$

LAND DESCRIBED IN SCHEDULE OF PARCELS

LOCAL GOVERNMENT AREA CANTERBURY-BANKSTOWN

PARISH OF BANKSTOWN COUNTY OF CUMBERLAND

TITLE DIAGRAM DP432479

FIRST SCHEDULE

HER MOST GRACIOUS MAJESTY QUEEN ELIZABETH THE SECOND (ATTORNEY GENERAL'S DEPARTMENT).

(R AA630036)□

SECOND SCHEDULE (3 NOTIFICATIONS) \square

- 1 RESERVATIONS AND CONDITIONS IN THE CROWN GRANT(S)
- 2 A188474 COVENANT AS REGARDS THE PART OF LOT B FORMERLY IN LOT 12 SEC.1 DP5541 \square
- 3 A188475 COVENANT AS REGARDS LOT C AND THE PART OF LOT B \Box FORMERLY IN LOT 11 SEC.1 DP5541 \Box

NOTATIONS

UNREGISTERED DEALINGS: NIL

SCHEDULE OF PARCELS

LOT B IN DP432479 LOT C IN DP432479.

*** END OF SEARCH ***

Bankstown 432479 PRINTED ON 18/11/2021

^{*} Any entries preceded by an asterisk do not appear on the current edition of the Certificate of Title. Warning: the information appearing under notations has not been formally recorded in the Register. InfoTrack an approved NSW Information Broker hereby certifies that the information contained in this document has been provided electronically by the Registrar General in accordance with Section 96B(2) of the Real Property Act 1900.



ABN: 36 092 724 251 Ph: 02 9099 7400 (Ph: 0412 199 304)

Level 14, 135 King Street, Sydney Sydney 2000 GPO Box 4103 Sydney NSW 2001 DX 967 Sydney

Summary of Owners Report

Address: - 369 Chapel Rd, Bankstown 2200

Description: - Lot 10 in D.P. 5541

Date of Acquisition and term held	Registered Proprietor(s) & Occupations where available	Reference to Title at Acquisition and sale
02.05.1918 (1918 to 1947)	Ellis May Forrester (Spinster)	Vol 2841 Fol 49
10.04.1947 (1947 to 1989)	Minister for Public Works (for the purposes of a Court House)	Vol 2841 Fol 49
31.10.1989 (1989 to Date)	Her Most Gracious Majesty Queen Elizabeth II on behalf of The Attorney-General for the Attorney-General's Department	Vol 2841 Fol 49 Now 10/5541

Denotes current registered proprietor

Leases & Easements: - NIL

Yours Sincerely Harrison Byrne (Checked by Mark Groll) 22nd November 2021




Cadastral Records Enquiry Report: Lot 10 DP 5541

Parish: BANKSTOWN

Ref: 369 Chapel Rd, Bankstown 2200

Locality: BANKSTOWN **LGA:** CANTERBURY-BANKSTOWN **County: CUMBERLAND**

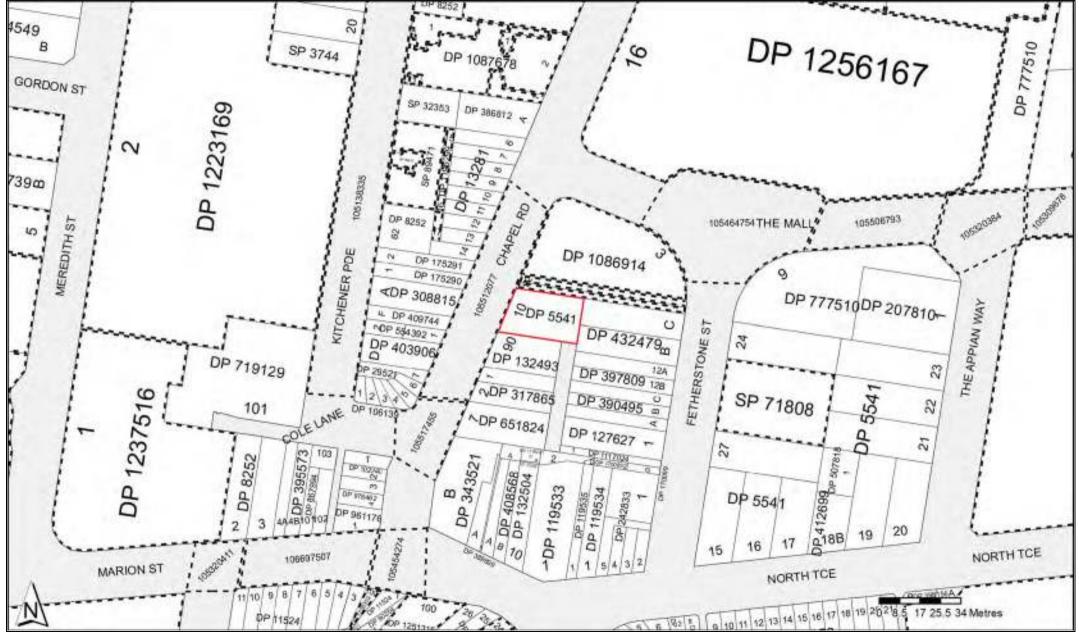

PLAN OF SECTION I

-CREENACRE PARK ESTATE -

BANKSTOWN.


being a subdivision of J. Marshalls 40 acre Grant.

PARISH OF BANKSTOWN COUNTY OF CUMBERLAND.

Scale: 80 feet to one inch.

COPY OF

D.P. 5541.

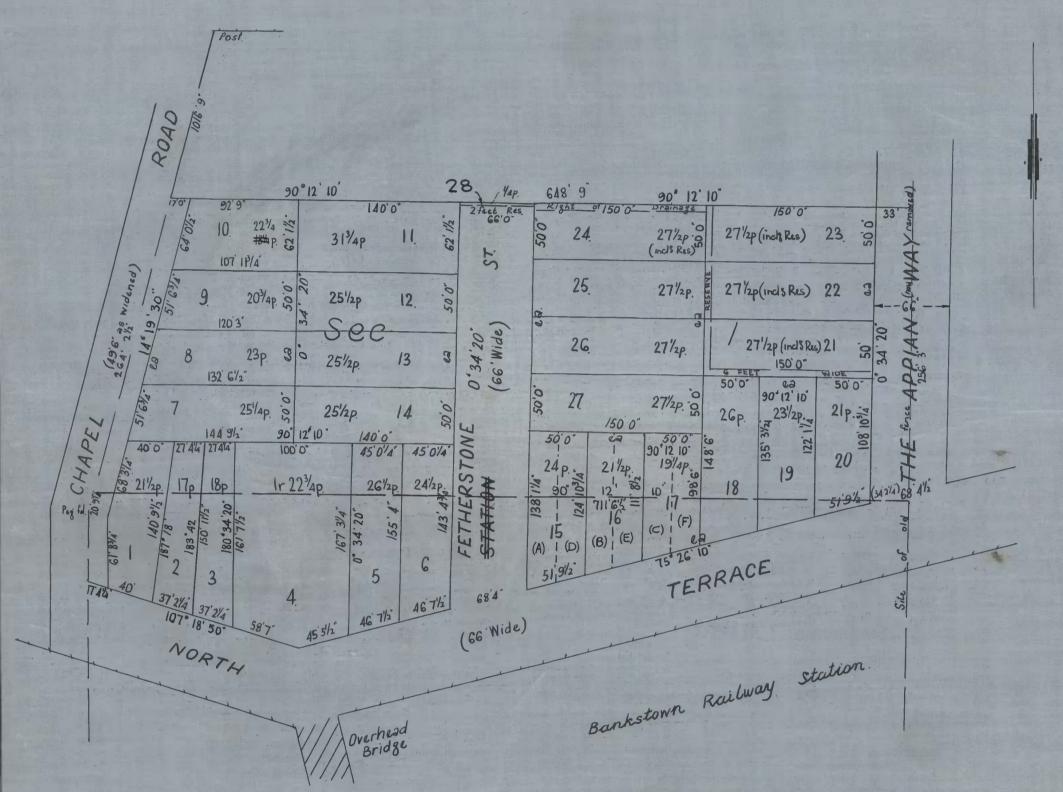

Date of Survey February 1908. Azimuth from Main Southern Road.

En & Cowdeny.

11/1/19

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22	1 1/4 4 1/4	6.735 8.335
33	-	10.06
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40	- 1/4	11.335
43		13.225
45 45	0 1/4 5 1/2	13.72 13.855
46	7 1/2	14.21
49	6	15.09
50 51	6 3/4	15.24 15.715
51	9 1/2	15.785
58	6 7/8	17.855
58 61	7 0 1/2	17.855 18.605
61	8 3/4	18.815
62	1 1/2 0 1/2	18.935
66	- 1/2	19.52 20.115
68	3 1/4	20.81
68	4 1/2	20.83
92	9	28.27
98	6	30.025
100	11 3/4	30.48
108	10 3/4	33.19
111	8 1/2	34.05
120	3 1 1/4	36.65 37.215
124	10 3/4	38.07
132	6 1/2	40.4
138	3 1/2 1 1/4	41.235 42.095
140	-	42.67
140	9 1/2 4 3/4	42.915 43.705
144	9 1/2	44.13
148	6	45.265
150 150	11 1/2	45.72
153	11 1/2	46.925
155	4	47.345
161	7 1/2 3 1/4	49.265 50.98
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-	- 27 1/2	695.6
-	- 31 3/4	803
	1 22 3/4	1587



LAND Historical REGISTRY SERVICES Title



NEW SOUTH WALES LAND REGISTRY SERVICES - HISTORICAL SEARCH

FOLIO: 10/5541D

First Title(s): OLD SYSTEM

Prior Title(s): VOL 2841 FOL 49

Recorded	Number	Type of Instrument	C.T. Issue□
18/5/1994		CONVERTED TO COMPUTER FOLIO	FOLIO CREATEDO
19/4/1999	5757162	DEPARTMENTAL DEALING	

*** END OF SEARCH ***

Received: 18/11/2021 17:35:48





NEW SOUTH WALES LAND REGISTRY SERVICES - TITLE SEARCH

FOLIO: 10/5541D

 SEARCH DATE
 TIME
 EDITION NO
 DATE

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 18/11/2021
 5:35 PM

VOL 2841 FOL 49 IS THE CURRENT CERTIFICATE OF TITLE

 $\mathtt{LAND}\square$

LOT 10 IN DEPOSITED PLAN 5541

LOCAL GOVERNMENT AREA CANTERBURY-BANKSTOWN PARISH OF BANKSTOWN COUNTY OF CUMBERLAND

TITLE DIAGRAM DP5541

FIRST SCHEDULE

HER MOST GRACIOUS MAJESTY QUEEN ELIZABETH II ON BEHALF OF☐
THE ATTORNEY-GENERAL FOR THE ATTORNEY-GENERAL'S DEPARTMENT☐

SECOND SCHEDULE (1 NOTIFICATION) \square

* 1 D666659 LAND EXCLUDES MINERALS (S.141 PUBLIC WORKS ACT, \Box 1912) \Box

NOTATIONS

UNREGISTERED DEALINGS: NIL

*** END OF SEARCH ***

369 Chapel Rd, Bankstown 2200

PRINTED ON 18/11/2021

Appendix D

Historical Aerial Photographs



Douglas Partners

Geotechnics | Environment | Groundwater

CLIENT: City of Canterbury Bankstown

OFFICE: Sydney DRAWN BY: ZW

SCALE: 1:800 @ A3 DATE: 03.12.2021

TITLE: 1943 Historical Aerial Imagery
Preliminary Site (Contamination) Investigation
20 Fetherstone Street and 369 Chapel Road, Bankstown

	PROJECT No:	208123.00
/Ň/	DRAWING No:	Д
	REVISION:	C






CLIENT: City of Canterbury I	City of Canterbury Bankstown		
OFFICE: Sydney	DRAWN BY: ZW		
SCALE: 1:800 @ A3	DATE: 03.12.2021		

TITLE: 1955 Historical Aerial Imagery
Preliminary Site (Contamination) Investigation
20 Fetherstone Street and 369 Chapel Road, Bankstown


	PROJECT No:	208123.00
/ Ň /	DRAWING No:	В
	REVISION:	0

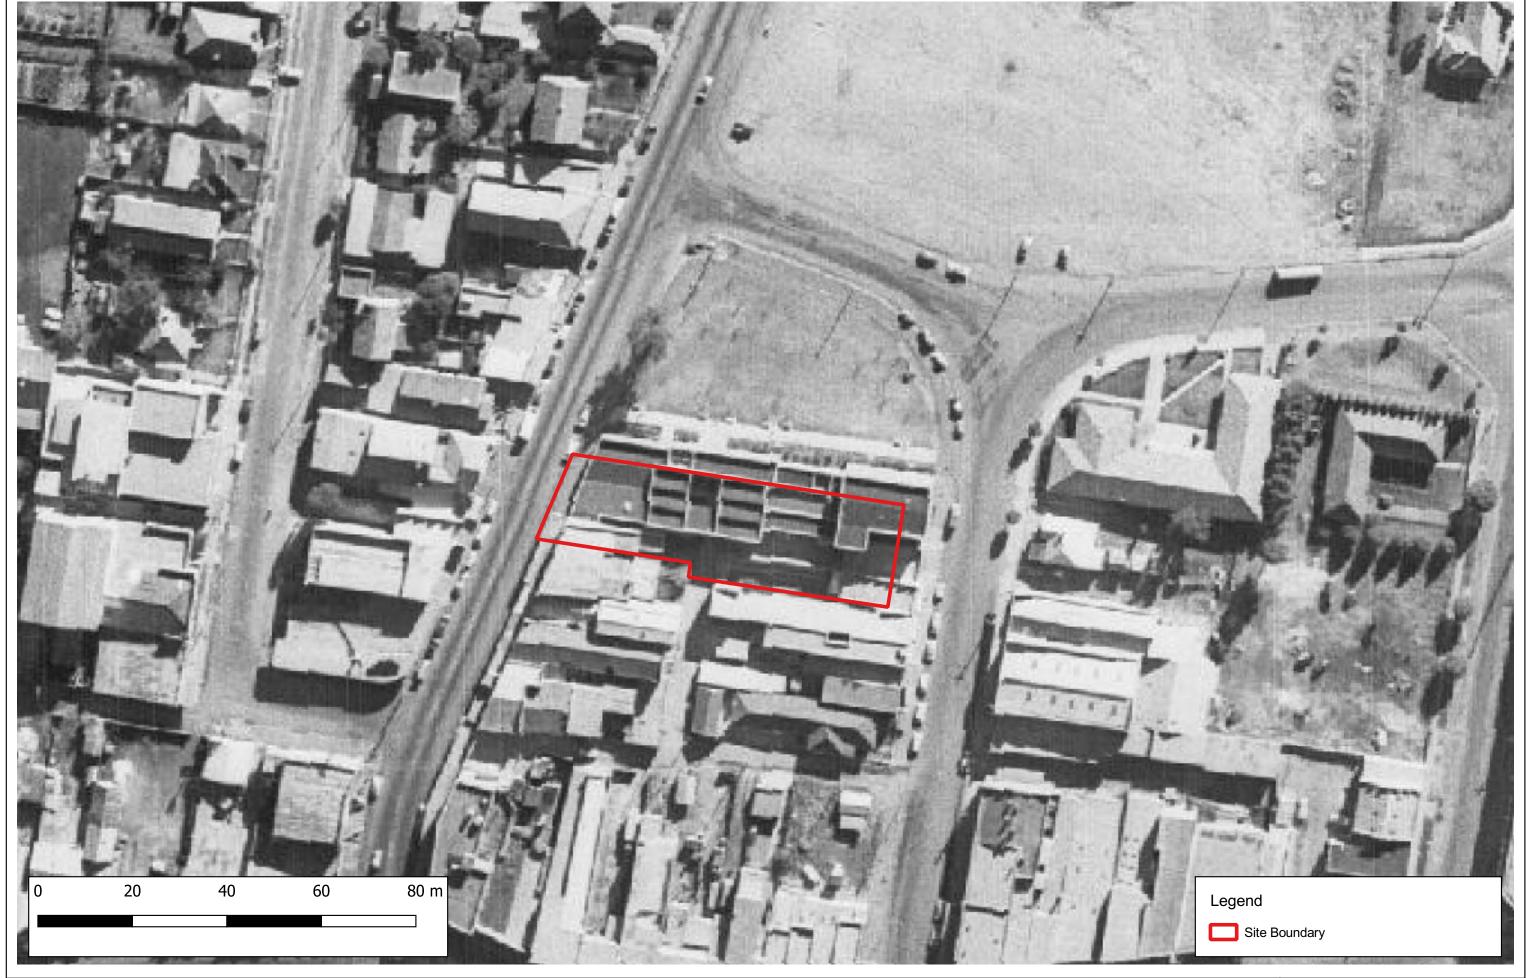




CLIENT: City of Canterbury I	NT: City of Canterbury Bankstown		
OFFICE: Sydney	DRAWN BY: ZW		
SCALE: 1:800 @ A3	DATE: 03.12.2021		

TITLE: 1961 Historical Aerial Imagery
Preliminary Site (Contamination) Investigation
20 Fetherstone Street and 369 Chapel Road, Bankstown

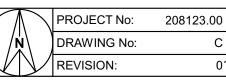

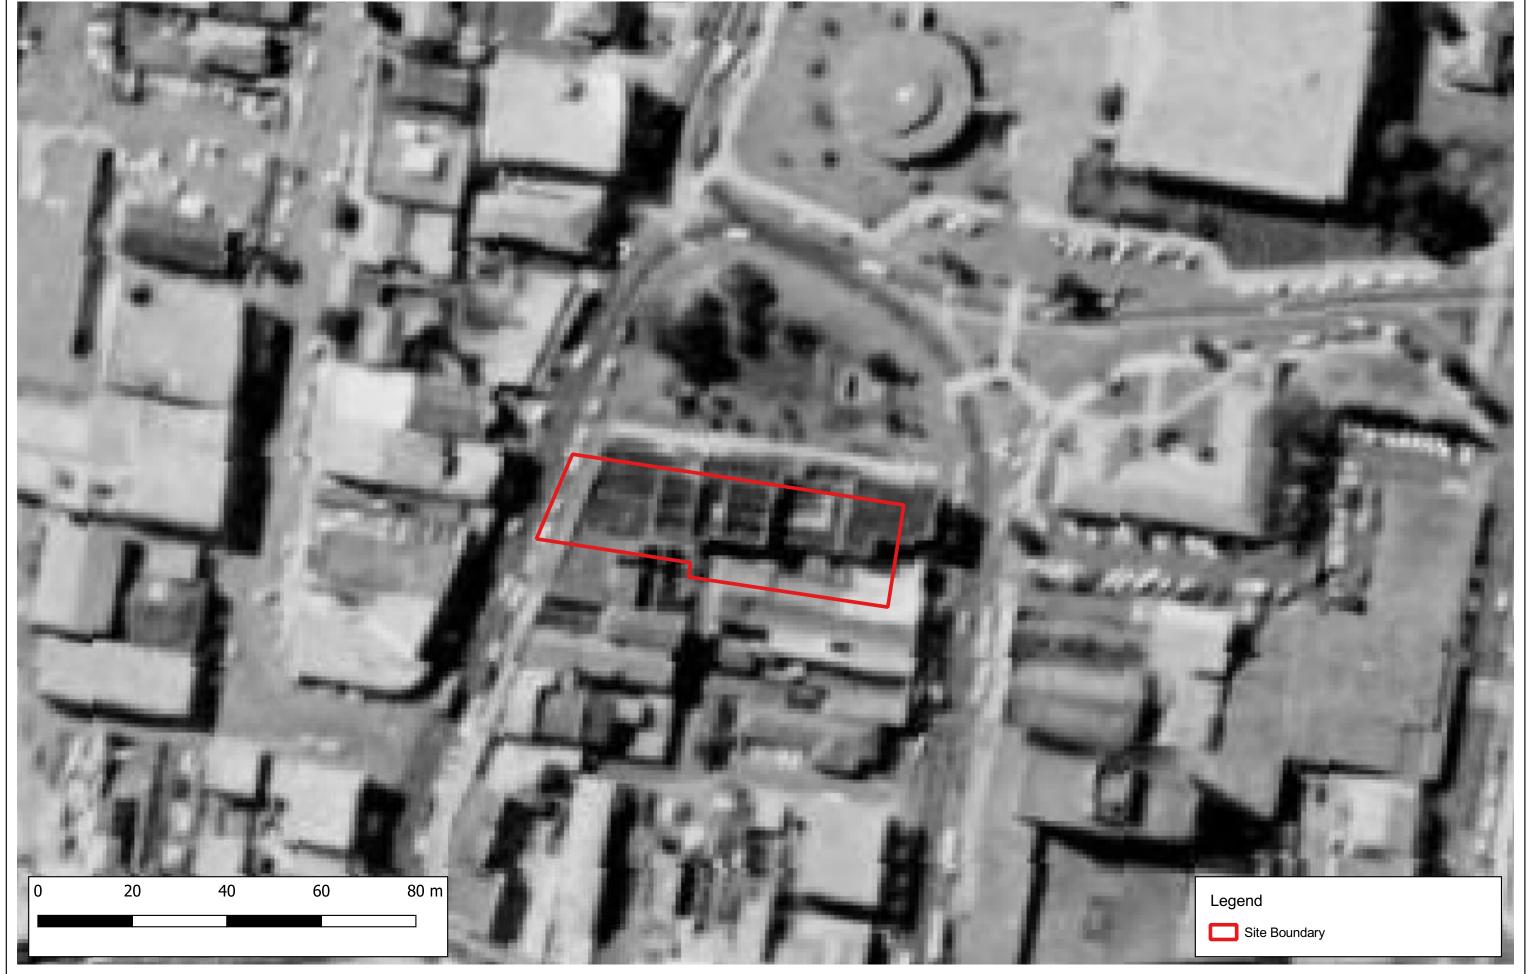



CLIENT: City of Canterbury Bankstown		
OFFICE: Sydney	FFICE: Sydney DRAWN BY: ZW	
SCALE: 1:800 @ A3	DATE: 03.12.2021	

TITLE: 1971 Historical Aerial Imagery
Preliminary Site (Contamination) Investigation
20 Fetherstone Street and 369 Chapel Road, Bankstown

	PROJECT No:	208123.00
/N\	DRAWING No:	D
	REVISION:	01





CLIENT: City of Canterbury I	City of Canterbury Bankstown	
OFFICE: Sydney	DRAWN BY: ZW	
SCALE: 1:800 @ A3	DATE: 03.12.2021	

TITLE: 1982 Historical Aerial Imagery
Preliminary Site (Contamination) Investigation
20 Fetherstone Street and 369 Chapel Road, Bankstown

	PROJECT No:	208123.00
/Ň/	DRAWING No:	Е
	REVISION:	0
·		





CLIENT: City of Canterbury	City of Canterbury Bankstown	
OFFICE: Sydney	DRAWN BY: ZW	
SCALE: 1:800 @ A3	DATE: 03.12.2021	

1991 Historical Aerial Imagery
 Preliminary Site (Contamination) Investigation
 20 Fetherstone Street and 369 Chapel Road, Bankstown

	PROJECT No:	208123.00
/Ň/	DRAWING No:	F
	REVISION:	0





CLIENT: City of Canterbury Bankstown		
OFFICE: Sydney	DRAWN BY: ZW	
SCALE: 1:800 @ A3	DATE: 03.12.2021	

TITLE: 1998 Historical Aerial Imagery
Preliminary Site (Contamination) Investigation
20 Fetherstone Street and 369 Chapel Road, Bankstown

	PROJECT No:	208123.00
ĺΝ̈́	DRAWING No:	G
	REVISION:	0





CLIENT: City of Canterbury I	City of Canterbury Bankstown		
OFFICE: Sydney	DRAWN BY: ZW		
SCALE: 1:800 @ A3	DATE: 03.12.2021		

TITLE: 2007 Historical Aerial Imagery
Preliminary Site (Contamination) Investigation
20 Fetherstone Street and 369 Chapel Road, Bankstown

	PROJECT No:	208123.00
/Ň/	DRAWING No:	Н
	REVISION:	0.





CLIENT: City of Canter	bury Bankstown
OFFICE: Sydney	DRAWN BY: ZW
SCALE: 1:800 @ A3	DATE: 03.12.2021

TITLE: 2016 Historical Aerial Imagery
Preliminary Site (Contamination) Investigation
20 Fetherstone Street and 369 Chapel Road, Bankstown

	PROJECT No:	208123.00
/Ň/)	DRAWING No:	I
	REVISION:	0.

Appendix E

SafeWork NSW Hazardous Chemicals Search

CANCELLED FILE 1996

NSW POLICE SERVICE

FEATHERSTONE ST BANKSTOWN 2200

35/0B858

Status: CANCELLED

Comments:


- 1 de l'anno de l'a
್ಯಾಂಟ್ ರೆ ಟ್U/G tanks fillod with sand/combrete/earth and sealed off
□ All agonds removed from site
□ Only exempt quantities of dgoods at site
□ U/G tanks now used for storing diesel
□ U/G tanks removed from site
☐ Duplicate of Cosnoe
□ U/G tank abandoned (method unknows)
o





Tel: (02) 888 4888 • Fax: (02) 878 4038

Workcover Authority
The Chief Inspector of Dangerous Goods
Locked Bag 10
Clarence Street
SYDNEY NSW 2000

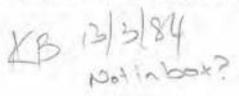

Dangerous Goods Act, 1975 Contractor's Certificate Abandonment of Underground Tanks

Gilbarco Aust Ltd hereby certifies that the tanks referred to in the Schedule of this Certificate have been taken out of service by the following method:

Removal of tank/s to an approved place.

 Filling with an inert solid material, sand or concrete. (Delete as applicable)

The procedure has been carried out under the provisions of the Dangerous Goods Act, 1975, and Section 9.8.13 of Australian Standard 1940-1993 and acceptance of the Chief Inspector of Dangerous Goods.

Owner of Premises: POLICE DEPARTMENT

Address of Premises: 18 - 20 FETHER STONE ST.

BANKSTOWN.

SCHEDULE

/ X Tank /6500 Litres
Tank Litres
Tank Litres
Tank Litres

Dated this /ST day of FERRUAR y 1996

GILBARCO AUST LTD Authorised Officer

uterfreerkoveraam

WORKCOVER NEW SOUTH WALES

DETAILS OF LICENCE FOR KEEPING DANGEROUS GOODS ON 4 JUNE 1996

Licence Number 35/013858

Expiry Date 15/08/89

Licensee Details

Licensee NSW POLICE SERVICE

Trading name

Postel Address COLLEGE ST, SYDNEY 2000

Licensee Contact

Site Details

Premises Licensed to Keep Dangerous Goods

FEATHERSTONE ST BANKSTOWN 2200

Nature of Site PRIVATE DWELLING Supplier NOT APPLICABLE

Emergency Contact ph.

Site staffing

Details of Depots

Depot No.	. Depot Type	Goods Stored in Depot	Qty
1	UNDERGROUND TANK	Class 3	2000 L

Appendix F

Council Planning Certificates and Records

Lot B DP 432479

20 Fetherstone Street, BANKSTOWN NSW 2200

Lot B DP 432479

20 Fetherstone Street, BANKSTOWN NSW 2200

PART 1: ENVIRONMENTAL PLANNING INSTRUMENTS

1.1 Principal Environmental Planning Instrument

Bankstown Local Environmental Plan 2015

Date effective from

5 March 2015

Land Use Zone

ZONE SP2 INFRASTRUCTURE: Public Administration Building

1. Permitted without consent

Nil

2. Permitted with consent

Aquaculture; Roads; The purpose shown on the <u>Land Zoning Map</u>, including any development that is ordinarily incidental or ancillary to development for that purpose

3. Prohibited

Any development not specified in item 1 or 2

The above information will assist in determining how the subject land may be developed. It is recommended that you read this section in conjunction with a full copy of any relevant environmental planning instrument as there may be additional provisions that affect how the land may be developed.

Note: The following information indicates those State Environmental Planning Policies (SEPP) which may apply to the subject land. A summary explanation of each SEPP can be sourced from the Department of Planning, Industry and Environment (DPIE) website at www.planning.nsw.gov.au. The full wording of each SEPP can also be accessed via the DPIE website.

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No. 21 - Caravan Parks

No. 33 - Hazardous and Offensive Development

No. 50 - Canal Estates

No. 55 - Remediation of Land

No. 64 - Advertising and Signage

No. 65 - Design Quality of Residential Apartment Development

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Greater Metropolitan Regional Environmental Plan

Georges River Catchment

Aims to protect the water quality of the Georges River and its tributaries and the environmental quality of the whole catchment. The objectives of the plan are to be achieved through coordinated land use planning and development control. The plan establishes the framework within which local, State and Federal agencies will consult so that there is a consistent approach to planning and development within the catchment.

Proposed State Environmental Planning Policies

Not applicable

1.3 <u>Proposed Environmental Planning Instruments (including any Planning Proposals) that are or have</u> been the subject of community consultation or on public exhibition under the Act

The land is affected by Planning Proposal (PP_2019_CBANK_005) which has been placed on public exhibition. The Planning Proposal seeks to produce a single set of planning rules for the Canterbury Bankstown Local Government Area and to implement key actions of current land use strategies.

1.4 Development Control Plans

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Contains detailed design guidelines and development standards for development in the former Bankstown City.

1.5 Contribution Plans

BANKSTOWN DEVELOPMENT CONTRIBUTIONS PLAN 2019

Development Contributions Plan prepared and adopted under the Environmental Planning and Assessment Act, 1979 and Environmental Planning and Assessment Regulation 2000.

The land is not affected by a heritage item or within a heritage conservation area under the relevant Principal Environmental Planning Instrument.

2.2 <u>Mine Subsidence</u>

The subject land is not within a mine subsidence district within the meaning of Section 20 of the *Coal Mine Subsidence Compensation Act 2017*.

2.3 Road Widening and Road Realignment

Whether or not the land is affected by a road widening or road realignment proposal under Division 2 or Part 3 of the Roads Act 1993 or an environmental planning instrument;

The land is not affected by a road widening or road realignment proposal under Division 2 or Part 3 of the Roads Act 1993, or an environmental planning instrument.

Whether or not the land is affected by a road widening or road realignment proposal under any resolution of Council.

The land is not affected by a road widening or road realignment proposal under any resolution of Council.

2.4 Council and Other Public Authority Policies on Hazard Risk Restrictions

Whether or not the land is affected by a policy adopted by Council or adopted by any other public authority (and notified to the Council for the express purpose of its adoption by that authority being referred to) that restricts the development of the land because of the likelihood of:

Land Slip

The land is not affected by a policy restriction relating to landslip

• Bushfire

Not applicable

• Tidal Inundation

The land is not affected by a policy restriction relating to tidal inundation

• Subsidence

The land is not affected by a policy restriction relating to subsidence

Acid Sulfate Soils

The land is not affected by a policy restriction relating to acid sulfate soils.

• Unhealthy Building Land

The land is not affected by a policy restriction relating to Unhealthy Building Land.

• Any Other Risk

Not applicable.

The land, or part of the land, is **not** within the flood planning area (FPA) or probable maximum flood (PMF).

The land, or part of the land, is **not** subject to flood related development controls.

2.6 Matters arising under the Contaminated Land Management Act, 1997.

Council is not aware of the land being affected by any matters as prescribed by Section 59 (2) of the *Contaminated Land Management Act 1997*.

Please refer to the NSW Environmental Protection Agency (EPA) for more information.

2.7 Land Reserved For Acquisition

There is no environmental planning instrument, or proposed environmental planning instrument, applying to the land that makes provision for the acquisition of the land (or any part thereof) by a public authority, as referred to in Section 3.15 of the Environmental Planning and Assessment Act 1979.

2.8 Property Vegetation Plans

Not applicable

2.9 Orders under Trees (Disputes Between Neighbours) Act 2006

Not applicable

2.10 <u>Directions under Part 3A</u>

Not applicable

2.11 Site Compatibility Certificates and Conditions for Seniors Housing

Not applicable

2.12 Site Compatibility Certificates for Infrastructure

Not applicable

2.13 Site Compatibility Certificates and Conditions for Affordable Rental Housing

Not applicable

2.14 <u>Annual charges under Local Government Act 1993 for coastal protection services that relate to</u>

existing coastal protection works

Not applicable

2.15 <u>Biodiversity Certified Land</u>

Not applicable

2.16 Paper Subdivision Information

Not applicable

2.17 <u>Site Verification Certificates</u>

Not applicable

2.18 Loose-Fill Asbestos Ceiling Insulation

Not applicable

2.19 Affected Building Notices and Building Product Rectification Orders

Not applicable

2.20 State Environmental Planning Policy (Western Sydney Aerotropolis) 2020

Not applicable

Whether or not the land is land on which complying development may be carried out under each of the Codes for complying development because of the provisions of clauses 1.17A(1) (c) to (e), (2), (3) and (4), 1.18(1)(c3) and 1.19 of State Environmental Planning Policy (Exempt and Complying Development Codes) 2008 and, if no complying development may be carried out on that land under that Policy, the reasons why complying development may not be carried out on that land. Note that in order for complying development to be able to be carried out, it must be permissible in the relevant zone in the first place.

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3.1 Additional Flood Planning Advice

In addition to Section 2.5 of this certificate, the following information may assist in interpreting the DCP:

Not applicable.

3.2 Tree Preservation Order

A tree preservation order applies to the whole of the City of Canterbury Bankstown.

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On 22 August 2017 Council adopted a policy on contaminated land. This policy will restrict development of land:

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3.4 General Advice Regarding Use of Property

Persons considering commencing a use of or purchasing a property are advised to seek confirmation that the current, or intended, use (as the case may be) has been approved by Council, or does not require Council approval. It is pointed out that the question of "existing use rights" within the meaning of the Environmental Planning and Assessment Act, 1979, is a complex matter, and that the commencement of a use without Council approval (where required) is unlawful and may be subject to enforcement action.

3.5 Other Matters

Not applicable.

MITCHELL NOBLE MANAGER SPATIAL PLANNING

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369 Chapel Road, BANKSTOWN NSW 2200

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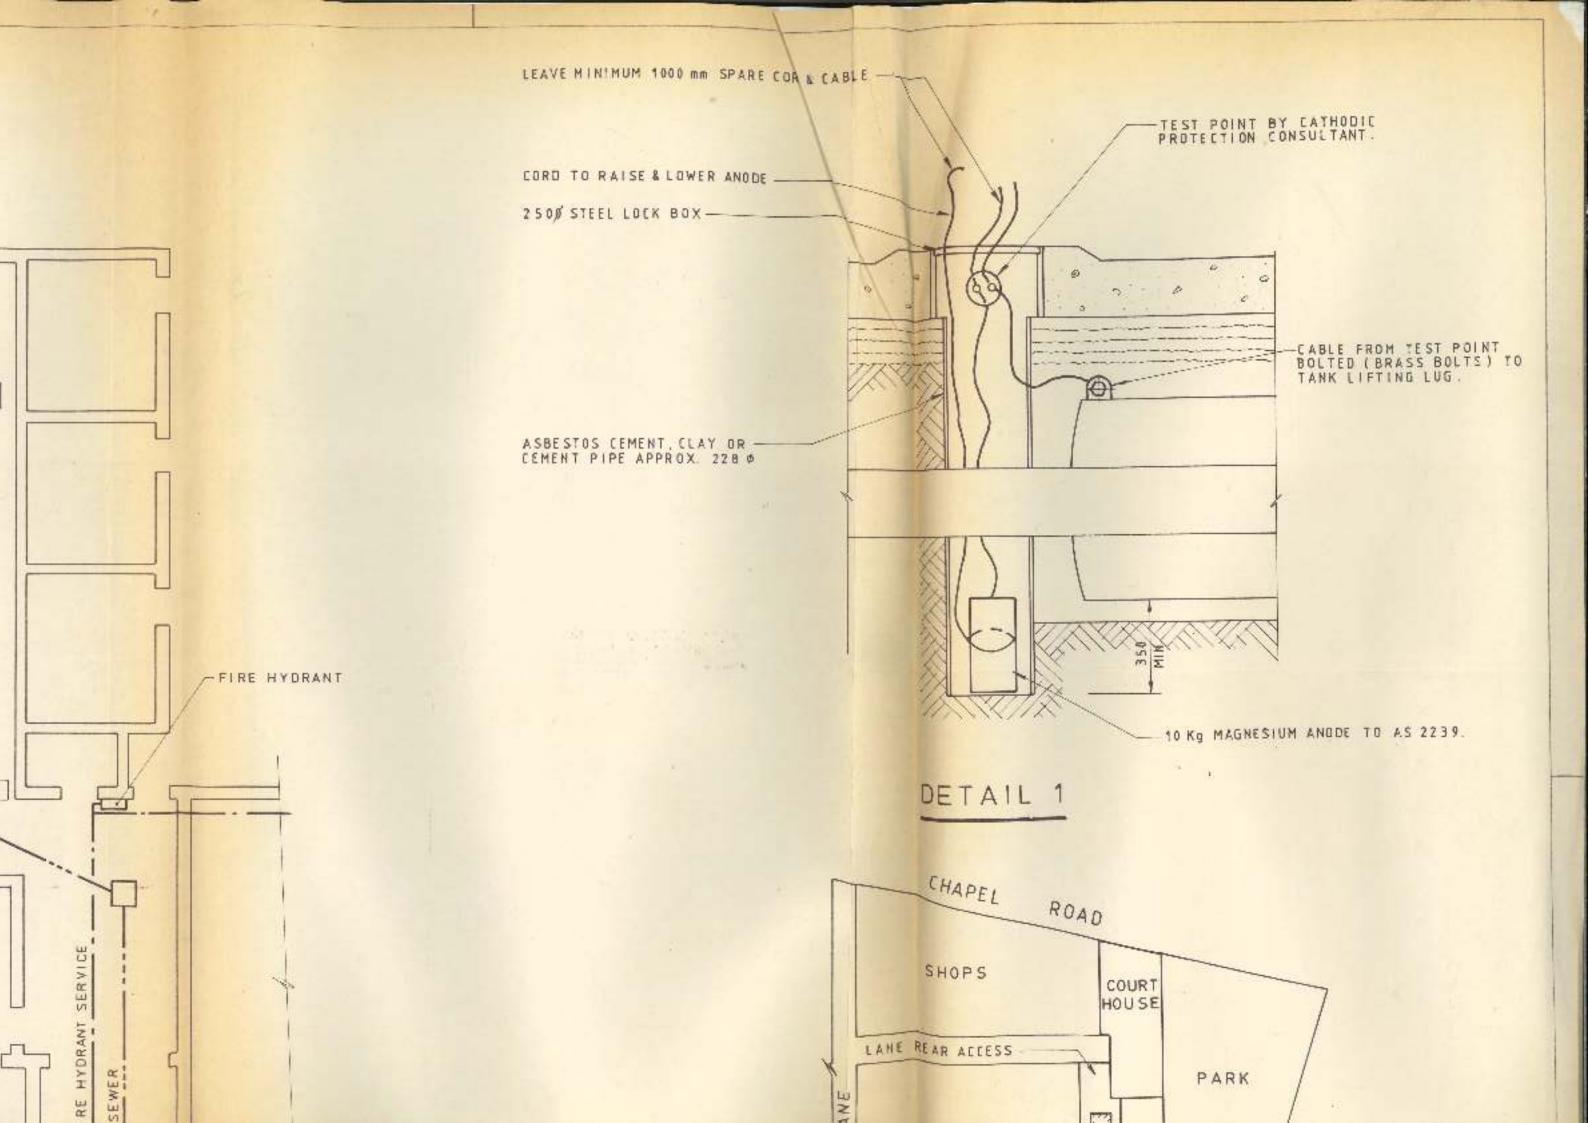
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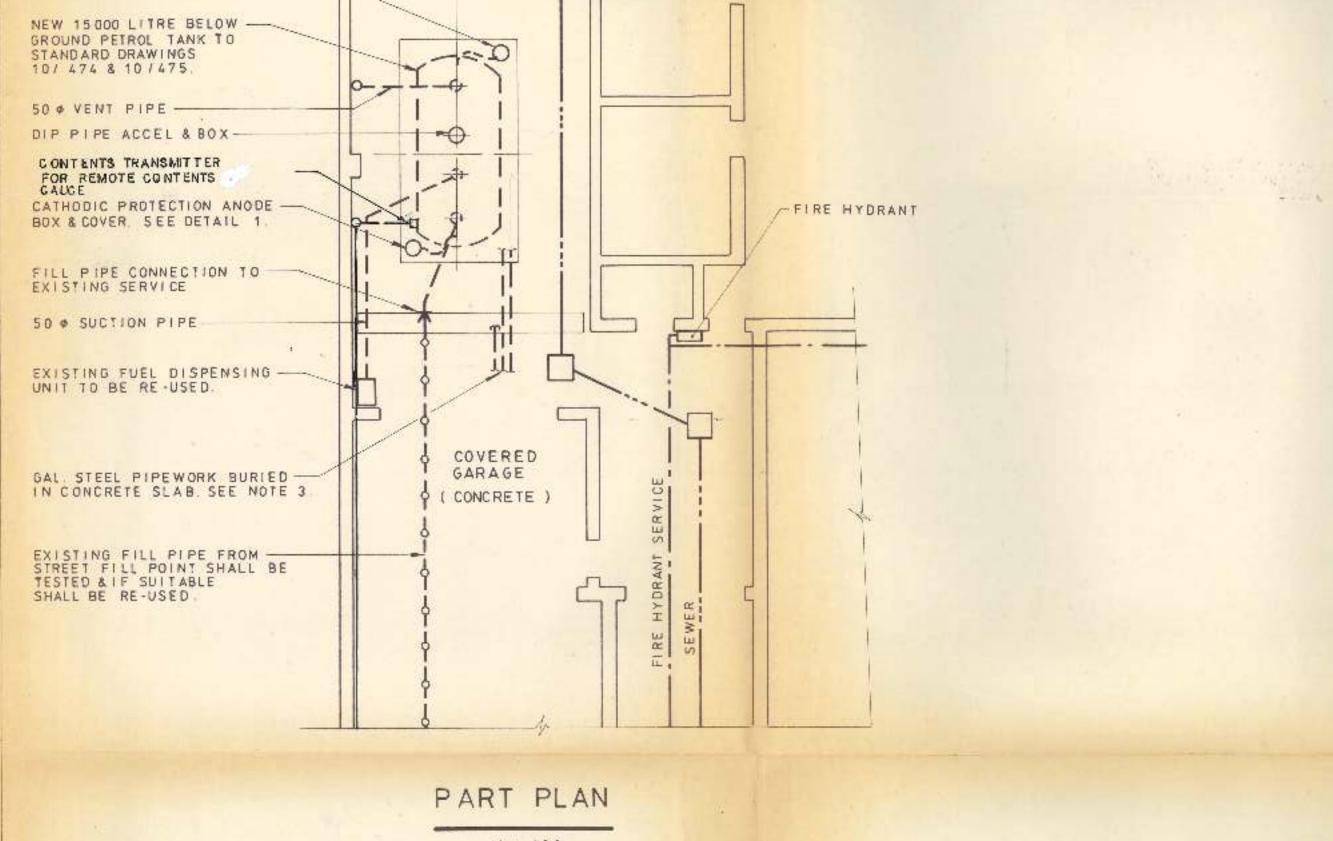
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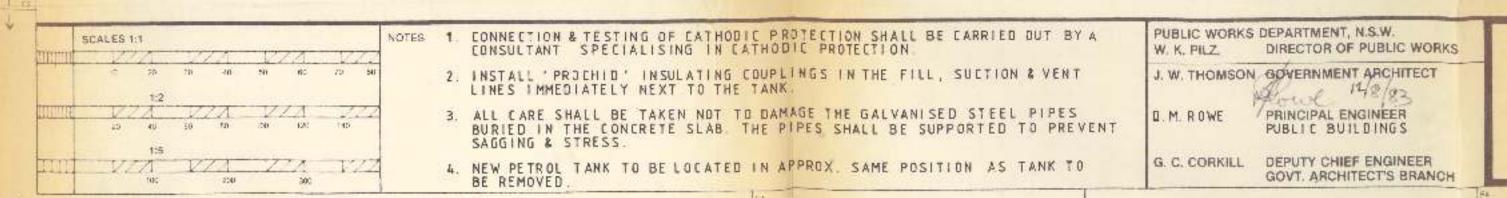
Not applicable.

MITCHELL NOBLE MANAGER SPATIAL PLANNING






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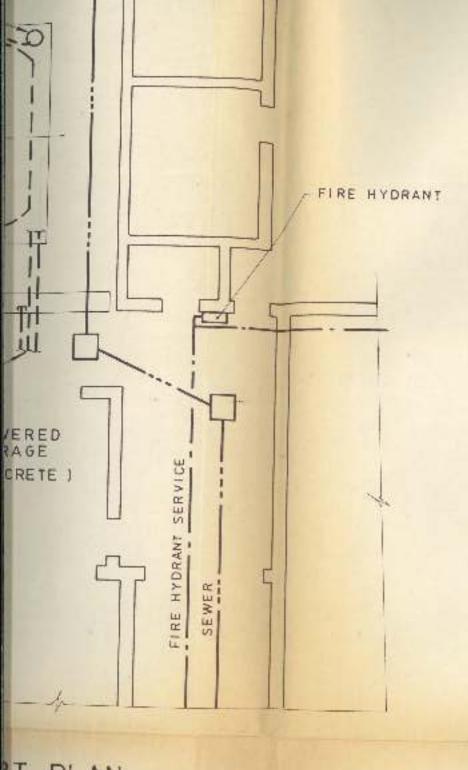


LANE R

REMOT


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T PLAN

1 : 100

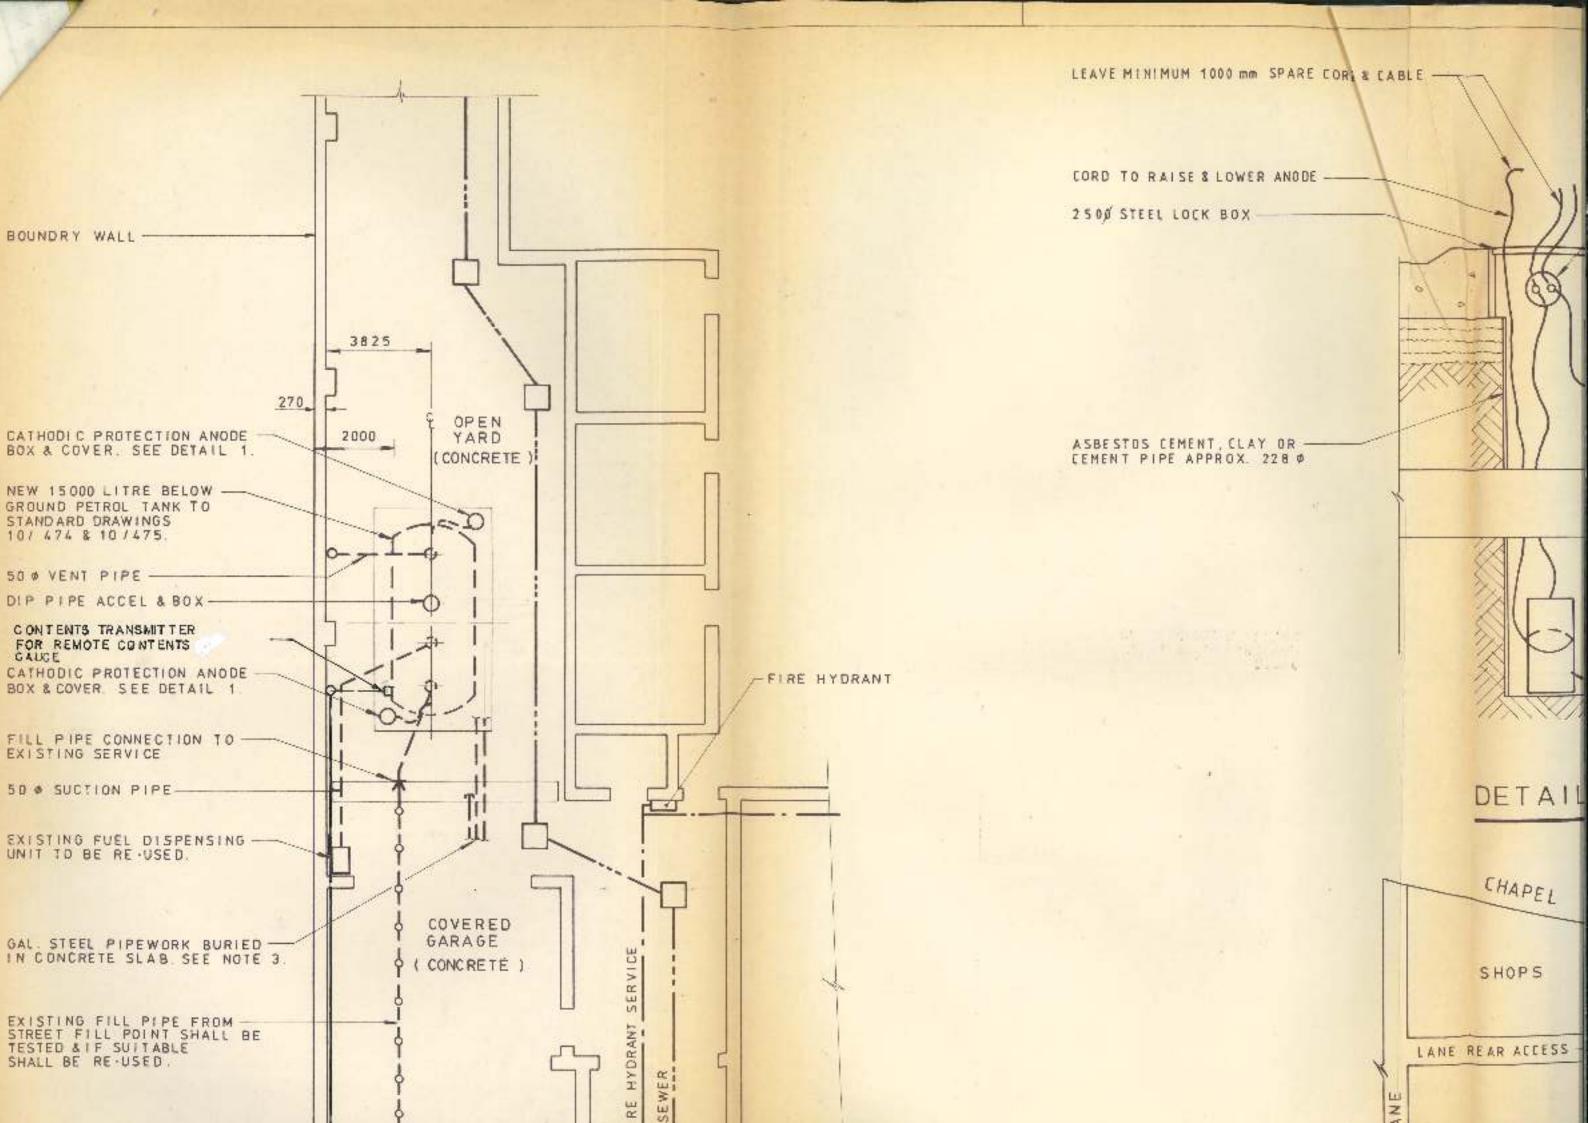

CHAPEL ROAD SHOPS COURT HOUSE LANE REAR ACCESS -PARK SHOPS POLICE STATION TANK LOCATION REMOTE CONTENTS GAUGE EXISTING FILL FEATHERSTONE ST

SITE PLAN

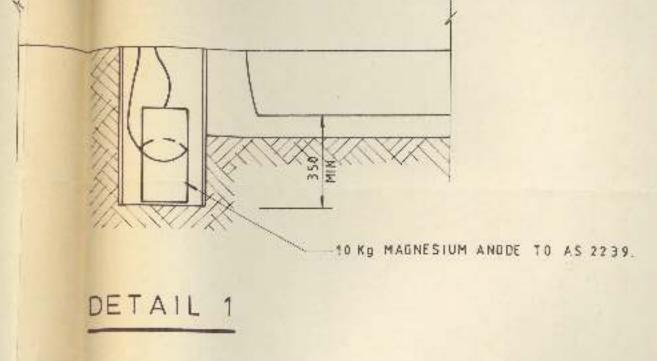N.T.S

TION & TESTING OF CATHODIC PROTECTION SHALL BE CARRIED OUT BY A

PROCHIO ' INSULATING COUPLINGS IN THE FILL, SUCTION & VENT

RE SHALL BE TAKEN NOT TO DAMAGE THE GALVANISED STEEL PIPES IN THE CONCRETE SLAB. THE PIPES SHALL BE SUPPORTED TO PREVENT

ROL TANK TO BE LOCATED IN APPROX. SAME POSITION AS TANK TO

PUBLIC WORKS DEPARTMENT, N.S.W. W. K. PILZ,

DIRECTOR OF PUBLIC WORKS

J. W. THOMSON, GOVERNMENT ARCHITECT Aller 148/22

D. M. ROWE

PRINCIPAL ENGINEER PUBLIC BUILDINGS

G. C. CORKILL

DEPUTY CHIEF ENGINEER GOVT. ARCHITECT'S BRANCH

BANKSTOWN POLICE STATION

15,000 L BELOW GROUND PETROL STORAGE TANK INSTALLATION.

PC 29 - 1/2 NUMBER NUMBER SHEET IN SET NUMBER

AS SHOWN

-GARAGE ENTRY





Public Works Department Page 1339 20 × 10 Public Works Department

200 George Street, Sydney 2000

Town Clerk, Bankstown City Council, The Mall BANKSTOWN 2200

3 1108 28 Our reference: B. 4986/19
Contact: Mr. R. Kerr
Telephone: 20586 Ext. 239

Attention: Mr. Tony Moody

1 6 AUG 1983

BANKSTOWN POLICE STATION PETROL TANK REPLACEMENT

RE-USE OF EXISTING FILL POINT


As discussed by phone on 15.8.83 I have enclosed a copy of Plan No.PC29-1/2

The proposed petrol tank installation replaces an existing installation of which there appears to be no Public Works Department or Council records.

The enclosed plan has been approved by the Dangerous Goods Branch of the Department of Industrial Relations, subject to the council providing approval of the location of the remote fill point.

The Department of Public Works seeks approval to re-use the existing fill point and would appreciate if urgent attention could be given to the matter.

> D. J. Pettigrew Secretary per: RC

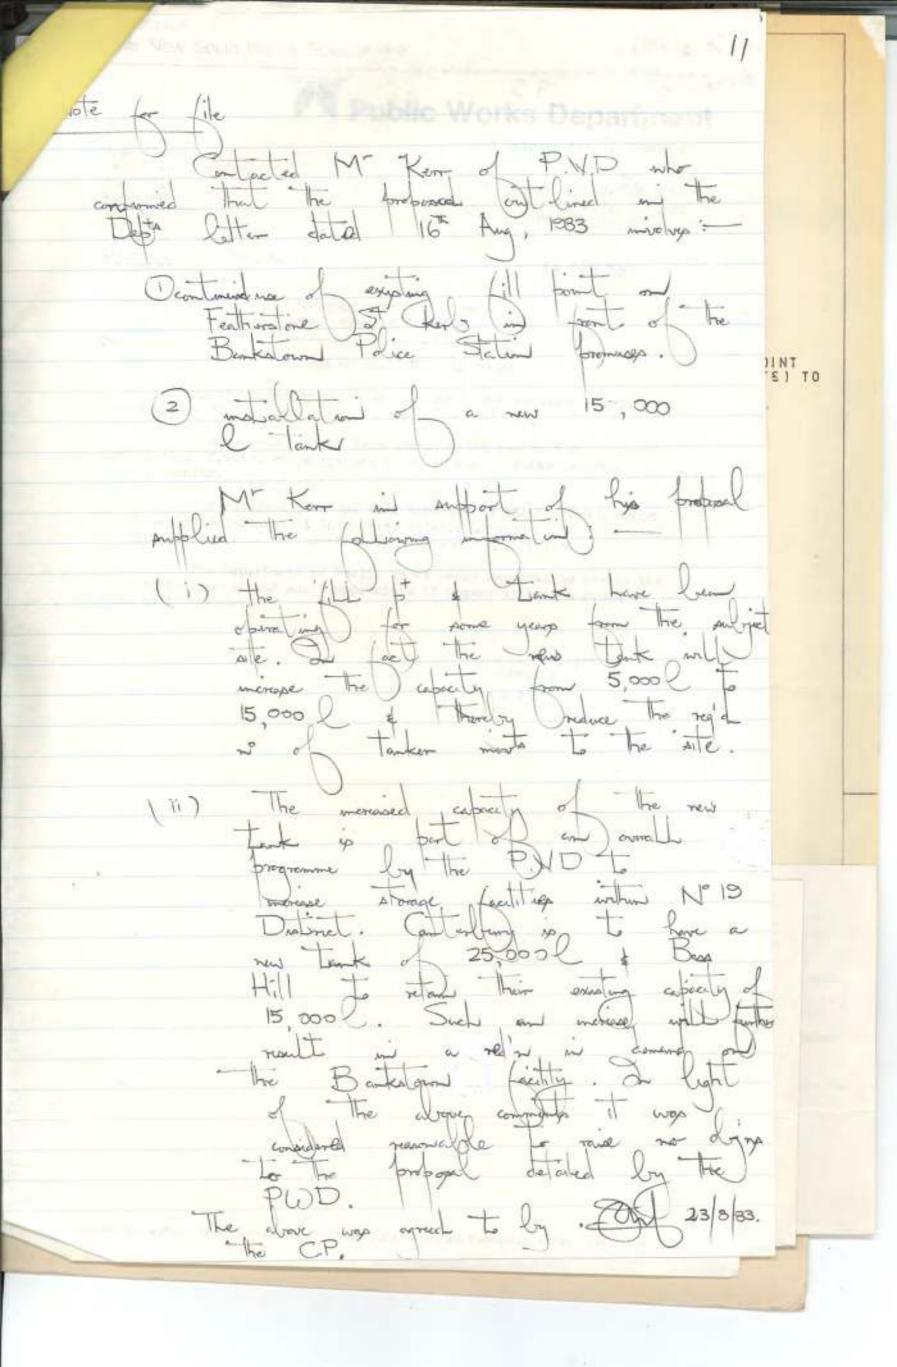

R T MOODY:UK

24 August 1983 P32/339/20/10

Mr D J Pettigrew Secretary Public Works Department 200 George Street SYDNEY NSW 2000

Dear Sir

RE: Bankstown Police Station Petherstone Street, Bankstown

In reply to your letter dated 16 August 1983 I wish to advise that no objection is raised to the installation of a new 150,000 litre petrol tank facility on the subject site as indicated on the submitted plan and the re-use of the existing filling point subject to the following requirements:

- (i) Compliance with the requirements of the Department of Industrial Relations;
- (ii) Tankers servicing the new petrol tank facility are not to stand within the adjoining bus stop area.

I trust that the above information is satisfactory.

Yours faithfully

A B Heiler TOWN CLERK

a Jak

88

N S W Department Of Commerce Sydney Regional Office PO Box 285 DOONSIDE NSW 2767

Attention: Jale Refik

Dear Madam,

APPLICATION NUMBER: DA-1340/2003

PROPOSAL: Demolition of existing Police Station and Courthouse buildings and

construction of a new Courthouse building including four courts,

ancillary facilities and car parking

PROPERTY: LOT 10 SEC 1 DP 5541, LOT B DP 432479, LOT C DP 432479,

LOT 90 DP 132493, No. 369 Chapel Road, BANKSTOWN NSW 2200, 20 Fetherstone Street, BANKSTOWN NSW 2200, 363

Chapel Road, BANKSTOWN NSW 2200

An assessment has been made of your development application. Please be advised that before your application can be considered for approval, the following matters shall be satisfactorily addressed:

Underground Storage Tank (UST)

1. The Geotechnical Investigation and Preliminary Environmental Site Assessment submitted with the application, prepared by NSW Department of Public Works and Services, states that "the plans indicate the existence of a disused, underground fuel storage tank (UST). However... the UST has been removed and backfilled some time ago".

However, the Site Contamination Assessment submitted with the application, prepared by New Environment, states that "it is not known how many tanks are on site" and "it is recommended that prior to redevelopment the tanks be removed".

The above statements do not provide a clear distinction as to the existence or otherwise of underground storage tanks (UST) at the subject site.

Café Location

2. Featherstone Street will undergo considerable upgrade in early 2004 and is anticipated to be the main pedestrian thoroughfare to Bankstown Rail Station from the Civic Precinct. As such, it is considered essential that the proposed café address the streetscapes of both The Mall (Memorial Park) and Featherstone Street.

Sheriff & Police Vehicle Parking

3. The proposal for additional Sheriff and/or Police vehicle parking spaces in Chapel Road is not supported. All staff parking should be provided within the site. Two existing Sheriff parking spaces and one Police parking space, together with the marked disabled parking space in Chapel Road will be retained.

Footpath Pavement Width

4. The 2 metre wide paved area adjacent to the proposed café at the north eastern corner of the site will not be adequate for the placement of tables and chairs, without a further application for the future use of part of the adjoining Memorial Park. The applicant shall therefore consider an extension in the width of the new paved area to accommodate both the placement of tables and chairs and pedestrians.

Relocation of Public Utilities

5. The cost of relocation of all public utility and plant equipment, including the existing telephone booth, shall be at full cost to the applicant. Further, the upgrading of the footpath paving in accordance with the CBD Masterplan and approved CBD footpath improvement plan shall be at the full cost of the applicant.

Building Service Connections

6. The proposed building service connections on the Chapel Road frontage shall be separated by a dwarf wall with appropriate screening landscaping.

Memorial Park Upgrade Works

7. Concern is raised at the minimal contribution to improvements in Memorial Park associated with the proposed development. Council seeks to discuss the proposed upgrade works further and the applicant is requested to contact Council's Service Planning and Commission (SPC) Group in this regard.

There is significant scope for improvement works to be activated on this important civic site. The redevelopment of the Bankstown Courthouse is an opportunity to collaborate with Council and local service personnel representatives on such upgrade works.

Public Artwork

8. The public artwork façade forms part of the Courthouse building and therefore must come under the maintenance regime of the Courthouse itself. Council will actively participate in the appraisal of artwork proposals made by the applicant, however Council is not in a position to determine artwork specifications for a building not owned or controlled by Council, or of such deliberate architectural detailing.

The above information should be submitted to Council within 21 days of the date of this letter (ie by the close of business on 24 October 2003).

Please also be advised that your application has been referred to Council's Development Engineers, Building Surveyors and Assets Management Branch for comment. Additional information or amended plans necessitated by these referrals will be requested in due course.

Should you have any enquiries regarding this matter, please contact me directly in Civic Approvals on 9707 9967 and please quote Council's application number.

Yours sincerely,

Daniel Bushby **DEVELOPMENT ASSESSMENT OFFICER**

Appendix G

Site Photographs



Photo 1: Bankstown Court House



Photo 2: Bankstown Court House



Site Photographs		PROJECT:	208123.00	
Preliminary Site Investigation (Contamination)		PLATE No:	1	
	erstone Street and 369 Road, Bankstown	REV:	1	
CLIENT	Canterbury Bankstown Council	DATE	29/11/2021	



Photo 3: Bankstown Court House

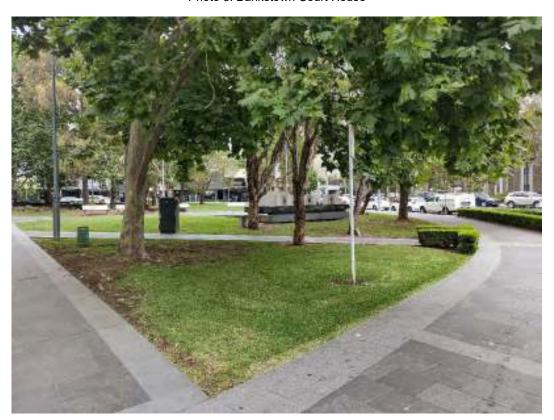


Photo 4: Grassed area north of site



Site Photographs		PROJECT:	208123.00	
Preliminary Site Investigation (Contamination)		PLATE No:	: 2	
	erstone Street and 369 Road, Bankstown	REV:	1	
CLIENT	Canterbury Bankstown Council	DATE	29/11/2021	



Photo 5: Rear lane access

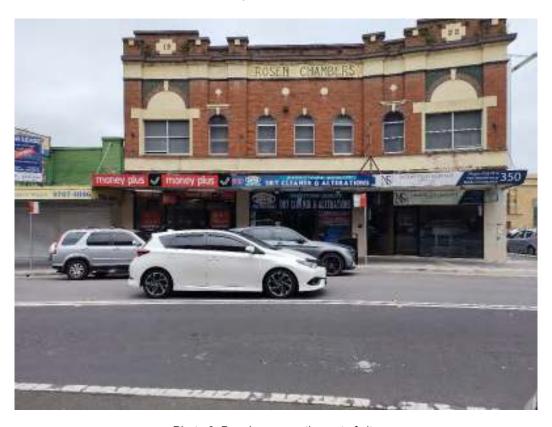


Photo 6: Dry cleaner south-west of site



Site Photographs		PROJECT:	208123.00	
Preliminary Site Investigation (Contamination)		PLATE No:	3	
	erstone Street and 369 Road, Bankstown	REV:	1	
CLIENT	Canterbury Bankstown Council	DATE	29/11/2021	

Appendix H

Risk Matrix



Appendix H

Risk Rating Matrix

The overall risk rating for the site has been determined by using the approach outlined in Tables H1 and H2 below. The risk matrix is based on:

- Probability of occurrence of each potential area of environmental concern (AEC), and / or contamination resulting from the potential AEC, based on the desktop site history and characterisation review, and
- Consequences of the AEC and / or contamination resulting from the AEC, which have been
 estimated on the basis of the contaminant type(s), likely impacted media, contaminant migration
 potential and prior project experience for similar sites. For the purpose of the risk rating, the
 contamination affects on human health and ecology have not been considered.

The risk rating is calculated using the formula: Risk Rating = Probability x Consequence. The final risk rating for the site has then been given by the maximum risk rating of all AECs. If contamination has already occurred, the risk rating is considered high irrespective of probability and consequence.

Table H1: Qualitative Probabilities and Consequences

Item	Description	Value
	AEC / contamination unlikely to occur	1
Drobobility	AEC / contamination may occur	2
Probability	AEC / contamination likely to occur	3
	AEC / contamination will occur	4
	Minimal impact not felt at source	1
	Impact limited to soil, and localised	2
	Widespread soil impact	3
Consequence	Impacts on multiple media (soil, groundwater, and soil vapour) but limited to site boundary	4
	Impacts on multiple media (soil, groundwater, and soil vapour) beyond the site boundary	5

Table H2: Risk Matrix

Tubio Tier Month						
		Consequence				
		1	2	3	4	5
Probability	1	1	2	3	4	5
	2	2	4	6	8	10
	3	3	6	9	12	15
	4	4	8	12	16	20
Risk 1-6=		Low				
Risk 7-12=		Medium	≥9 = medium-high risk			
Risk 13-20=		High				

Douglas Partners Pty Ltd